Instructions to contractors: The general contractor will be responsible for: all power and lighting circuits; low voltage cable tray in corridors, conduit, and wall penetrations between points of service and the MDF rooms; conduit between high school MDF room and middle school MDF room; conduit between MDF room and point of service in alley for data, cable and phone service; MDF room plywood backer; and ceiling grid and ceiling tile. The bidding contractor will be responsible for all low voltage wiring, hangers, terminations, connections, and labeling; installation of devices called out on plans including hangers, seismic bracing, cutting of ceiling tile, receptacle box trim and covers; fire sealant of all wall penetrations; installation of all MDF racks and equipment (not identified on plans - specified elsewhere) including connections; service between high school MDF room and middle school MDF room; testing and verification of all low voltage wiring and service. Low voltage wiring not in cable tray or conduit to be supported by hangers from ceiling joists, not from ceiling grid or ceiling grid hangers. Low voltage devices to be independently supported, not connected to ceiling grid. Rooftop and outdoor services require weatherproof covers. Refer to plans A1.3, A2.3 and A3.3 for low voltage layout and specific scope of work. Other plans included for reference.







MAGNOLIA SCIENCE ACADEMY 18220 SHERMAN WAY, RESEDA, CA 91335

BID SET 03-07-18


FRANCO ARCHITECTS INC 12345 Ventura Blvd. Studio City, CA 9160 Tel 818 754-20.

MAGNOLIA SCIENCE ACADEMY

PLAN CHECK #1 6/14/2017

FD PLAN CHECK 10/31/2017

FD PLAN CHECK 12/14/2017

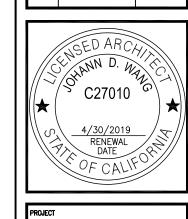

PROJECT ADDRESS

18220 SHERMAN WAY,
RESEDA, CA91335

DRAWING TITLE

COVER

DRAWN BY ISSUE DATE
12/14/20

JOB NUMBER DRAWING SCALE
AS NOTE

 \parallel AO.O

PROJECT INFORMATION

MAGNOLIA SCIENCE ACADEMY

18220 SHERMAN WAY, RESEDA, CA91335

APPLICABLE CODES: 2016 CA BUILDING CODE (2016 CBC), LA BUILDING CODE, FIRE ALARM SYSTEM PER 907.2.3.2, 907.2.3, 907.2.1

EDUCATION - 9 THRU 12TH GRADE

PROJECT:

LOCATION:

BUILDING USE:

 ∇Q

INDEX TO DRAWINGS

A0.1.1 ALTA SURVEY

PROJECT INFORMATION

DRAWING INDEX, SITE PLAN & LOCATION PLAN

ARCHITECTURAL

SPECIFICATION

SPECIFICATION

AS-1


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BID SET 03-07-18

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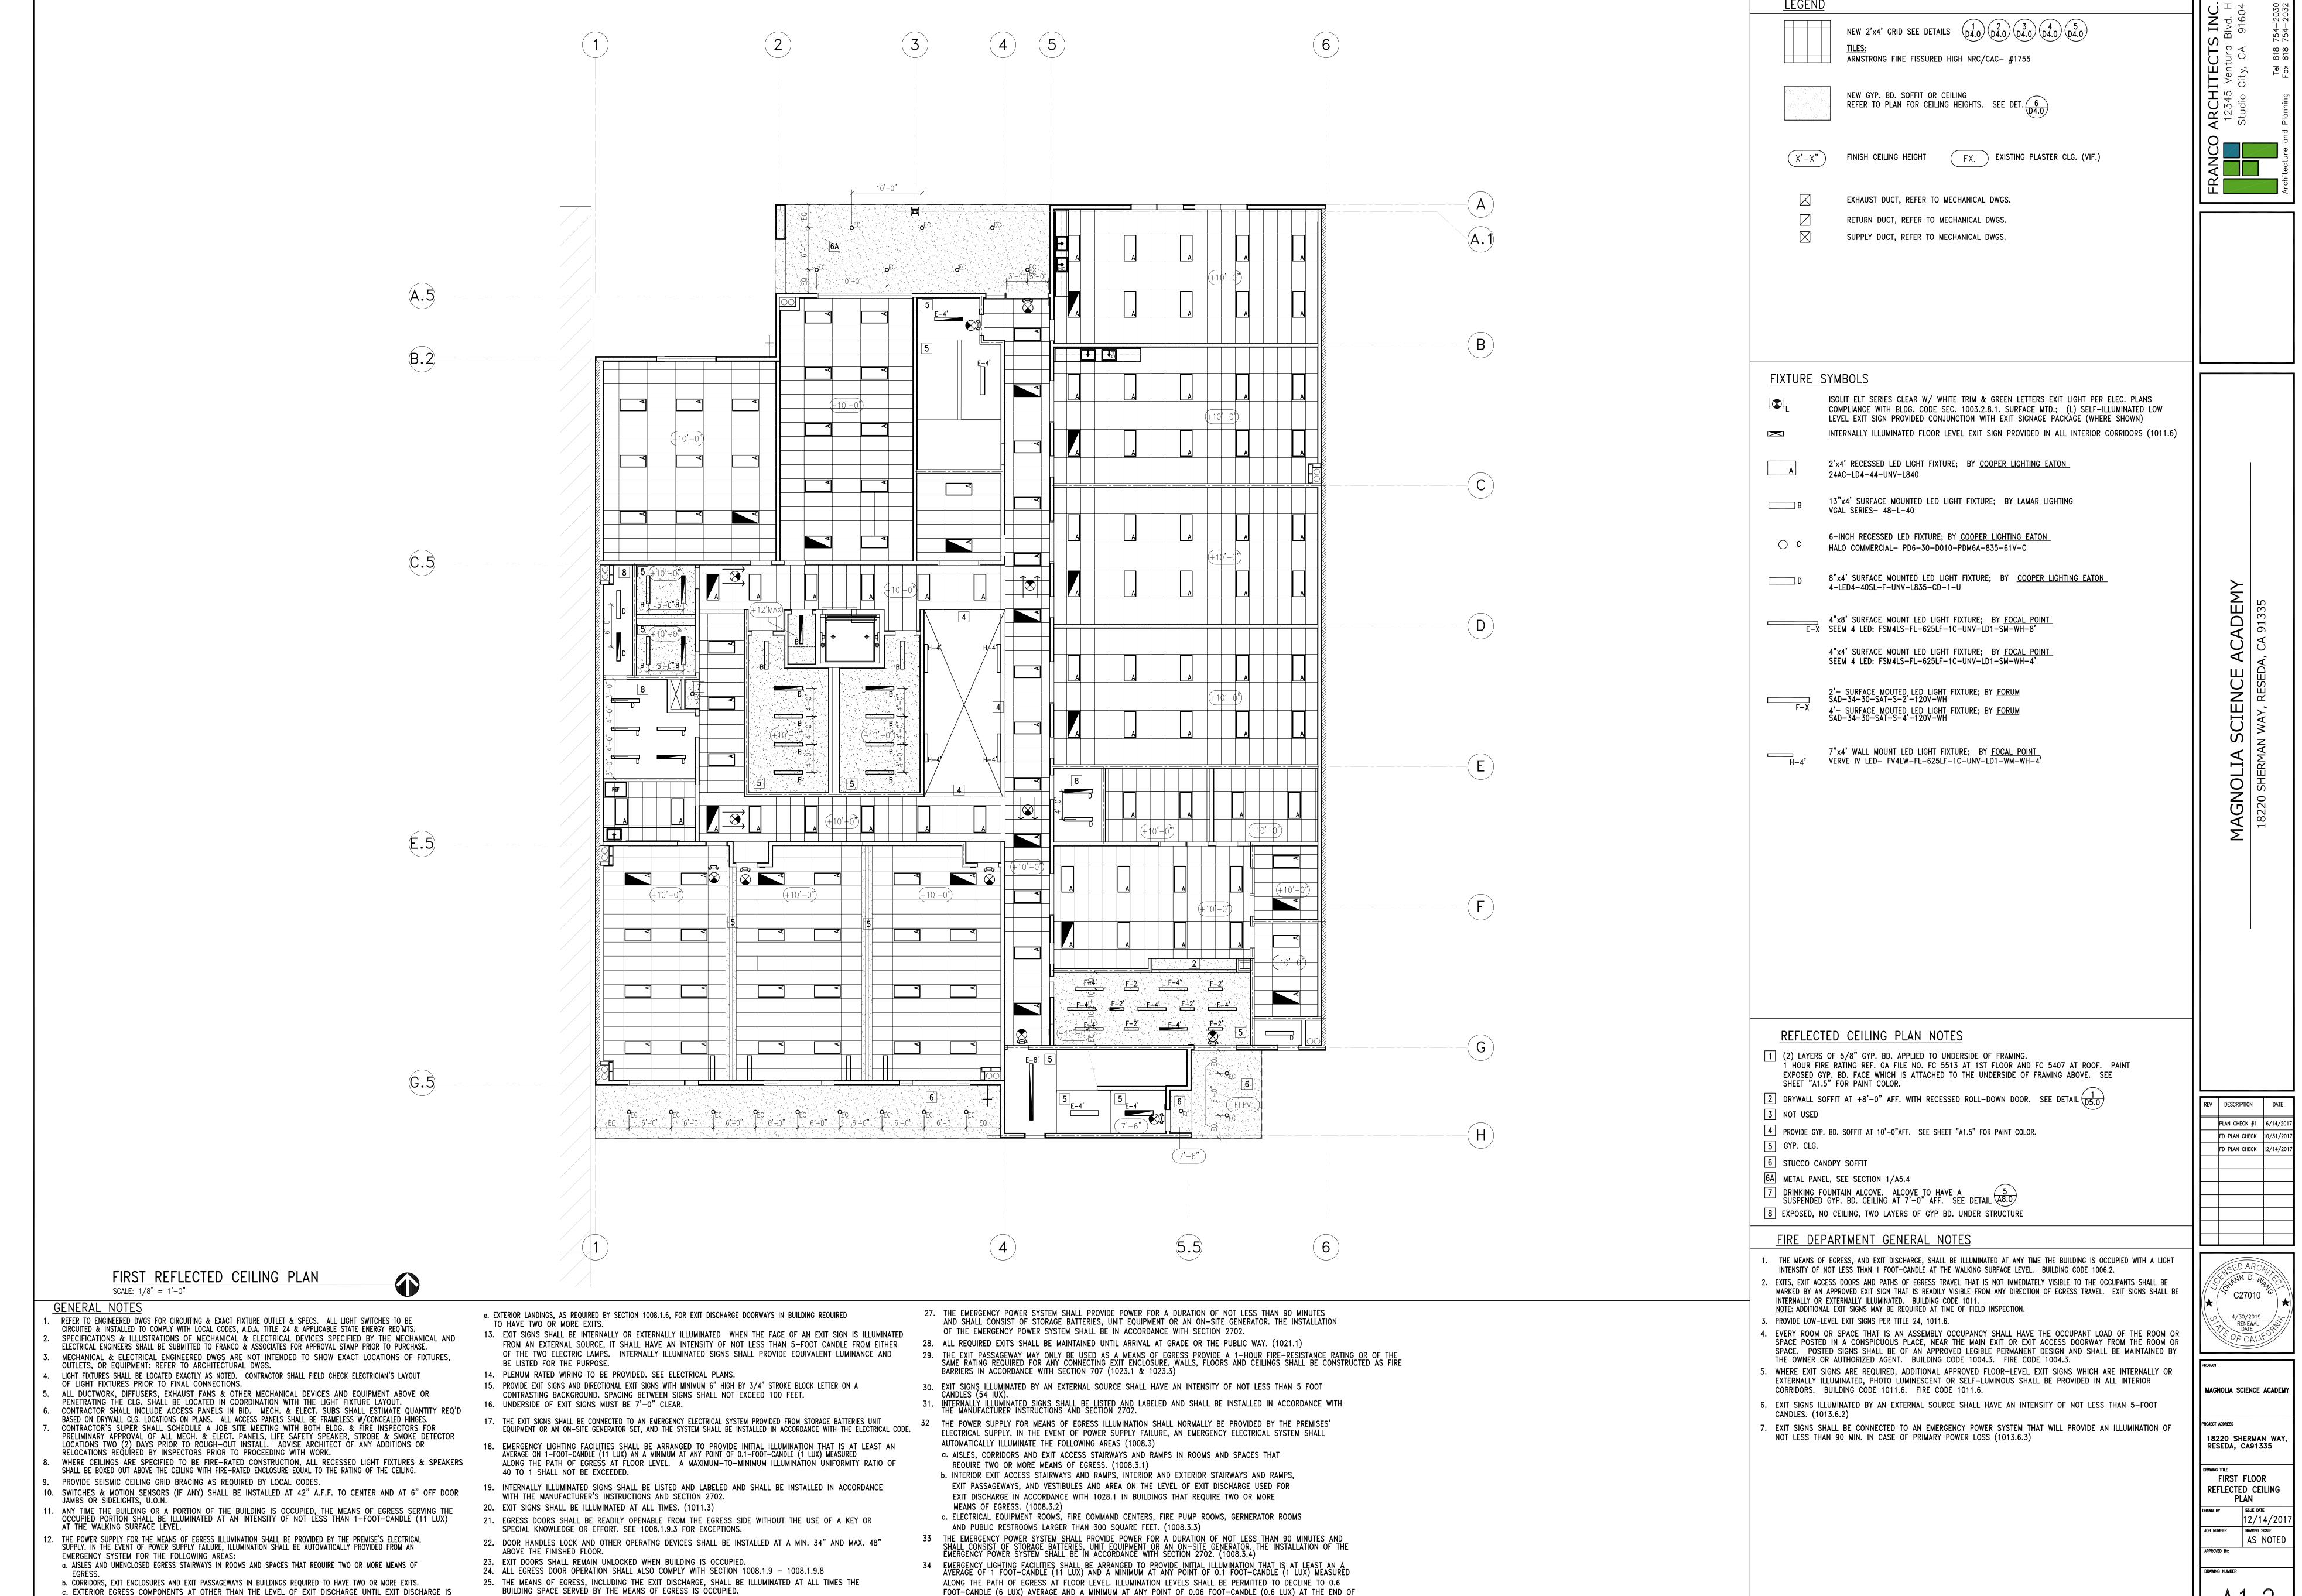
FIRE DEPARTMENT NOTES

USEAGE. (A5.303.2.3.1)

CA GREEN CODE NOTES

2. MAXIMUM CROSS SLOPE FOR WALKWAYS, HC DROP OFF AND RAMPS NOT EXCEED MORE THAN 2%.

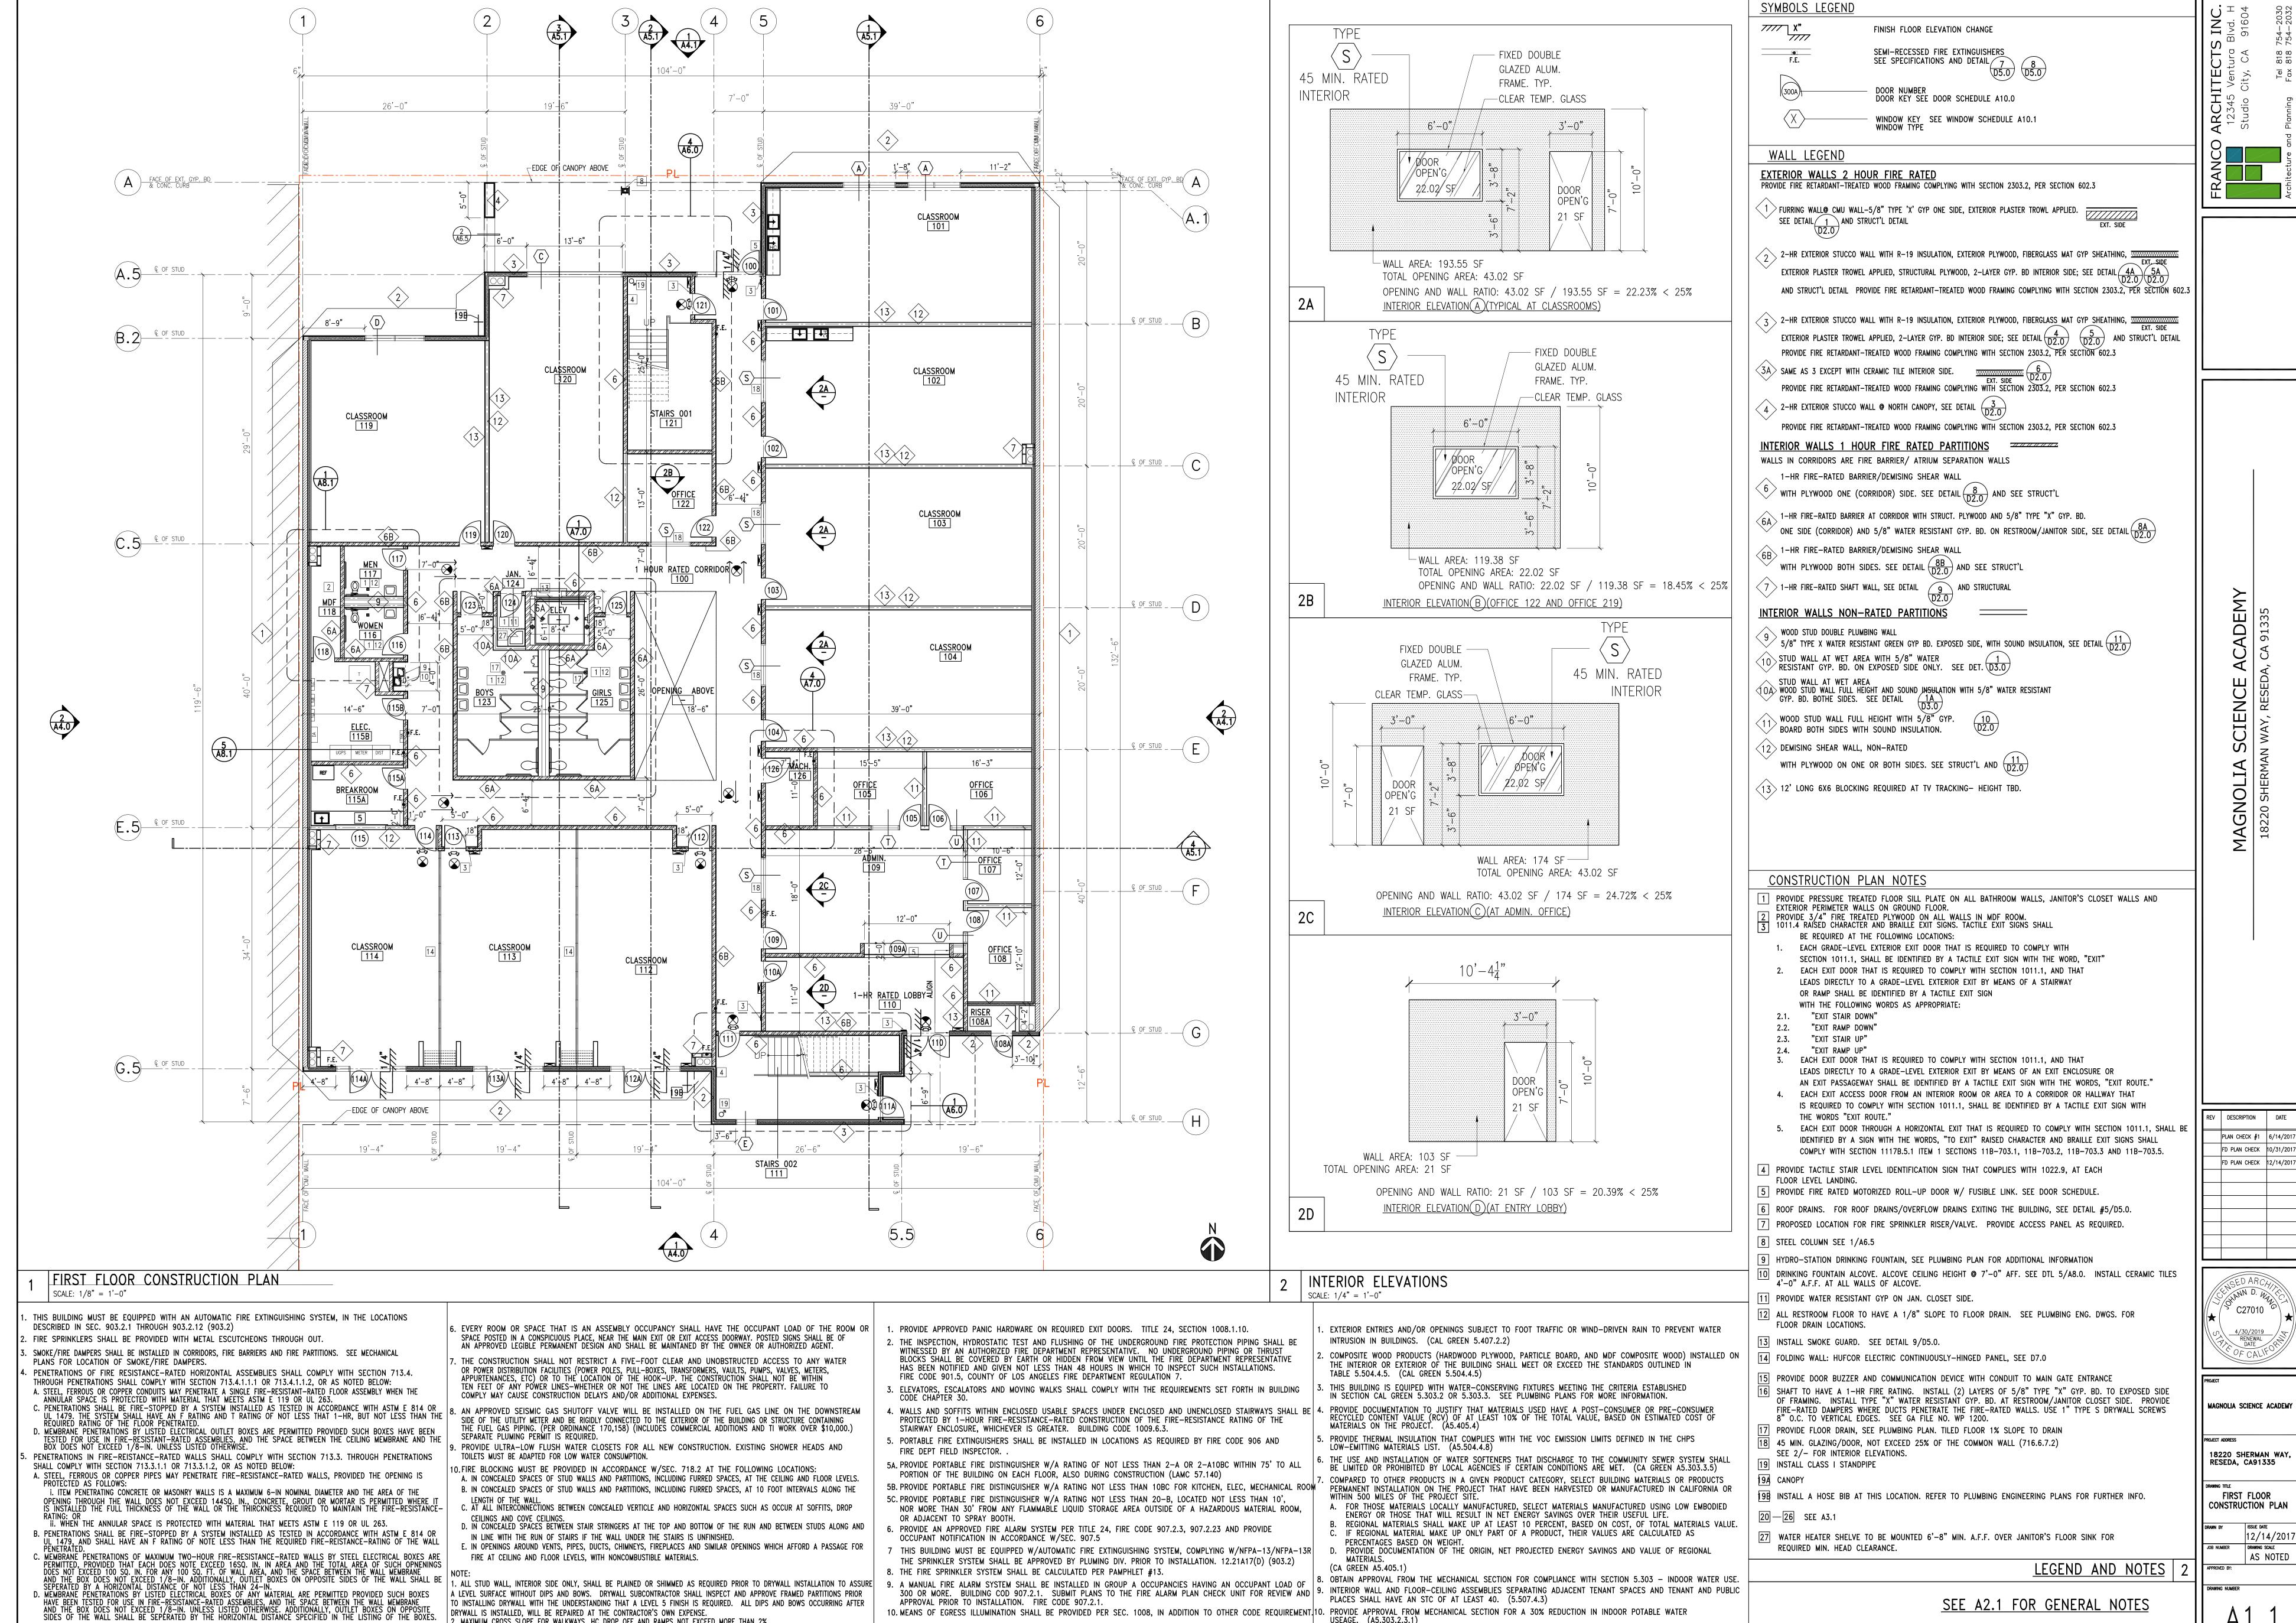BUILDING DEPARTMENT NOTES | 5



THE EMERGENCY LIGHTING TIME DURATION. A MAXIMUM-TOMINIMUM ILLUMINATION UNIFORMITY RATIO OF 40 TO 1

35 EXIT SIGNS SHALL BE INTERNALLY OR EXTERNALLY ILLUMINATED

26. THE MEANS OF EGRESS ILLUMINATION LEVEL SHALL NOT BE LESS THAN 1 FOOT-CANDLE AT THE

WALKING SURFACE.

ACCOMPLISHED FOR BUILDINGS TO HAVE TWO OR MORE EXITS.

OR MORE EXITS.

d. INTERIOR EXIT DISCHARGE ELEMENTS, AS PERMITTED IN SECTION 1027.1, IN BUILDINGS REQUIRED TO HAVE TWO

|| A1

BID SET 03-07-18

SPEAKER BY OTHERS - WIDE AREA ACCESS POINT IN CONDUIT REQUIRES DUPLEX BOX + CONDUIT TO CABLE TRAY (NO SEPARATE VOLUME CONTROL) VA = VIDEO ACCESS BOX - 3/4" CONDUIT TO CABLE TRAY TO OFFICE.NOTE: THESE ENTRANCE DOORS WILL HAVE ELECTRONIC LOCKS, CONTROLS IN OFFICE. W = WIDE AREA ACCESS POINT - BOX AND CONDUIT TO CABLE TRAY TEACHER LOCATION - VOIP + DATA QUAD BOX W/ 2EA 1.5" CONDUITS. ONE CONDUIT TO TV LOCATION IN ROOM - ONE CONDUIT TO CABLE TRAY TO MDF. TELEVISION/MONITOR LOCATION - TV/MOUNTING BRACKET/CABLING BY OTHERS REQUIRES DATA QUAD BOX WITH 2 CONDUITS LOCATED ABOVE CEILING -ONE 1.5" CONDUIT TO TL AND ONE 3/4" CONDUIT TO CABLE TRAY TO MDF ALSO NEEDS ABOVE CEILING — DUPLEX POWER 120V QUAD DATA BOX +3/4" CONDUIT TO CABLE TRAY TO MDF - MOUNT LOW ON WALL OR ABOVE LAB TABLES. CENTER ON WALL - NOTE: LOW WALL DATA BOX UNDER TV IN SECURITY CAMERA - EXTERIOR CAMERAS MOUNTED 10 FT ABOVE GRADE AND BELOW CANOPY AND PORCH ROOF - QUAD BOX + 3/4" CONDUIT TO CABLE TRAY TO MDF. CORRIDOR CAMERAS DEDICATED POWER CIRCUIT FOR PRINTER AND BREAKROOM APPLIANCES JUNCTION BOX FOR ELECTRICAL POWERED HAND DRYER, 20A CIRCUIT; CABLE TRAY RUN - SMALL TO ACCOMMODATE LOW VOLTAGE ONLY LOW VOLTAGE DEVICES AND WIRING TO BE BY OTHERS. BY OTHERS DEVICES INCLUDE: MDF EQUIPMENT UPS AND SERVER RACKS, CAT 5-6 WIRING AND HDTV

CABLES, COVER PLATES, CEILING AND WALL SPEAKERS, SPEAKER VOLUME CONTROL, TELEVISION MONITORS, TV MOUNTING BRACKETS, INDOOR AND OUTDOOR SECURITY CAMERAS AND MOUNTING BRACKETS, AND VIDEO ACCESS PANELS. DEVICES BY CONTRACTOR INCLUDE:

1 IN ALL THE CLASSROOMS, AT EACH FOURPLEX OUTLETS PROVIDE A 1-1/2" CONDUIT FOR DATA.

2 IN ALL THE CLASSROOMS, PROVIDE A DEDICATED CIRCUIT FOR EVERY TWO FOURPLEX OUTLETS.

DUPLEX RECEPTACLES, EACH ON A SEPARATE CIRCUIT. A DEDICATED 1.5 TON AC UNIT TO BE PROVIDED FOR THIS ROOM. CONTRACTOR TO COORDINATE AND CONFIRM ELECTRICAL REQUIREMENTS WITH CLIENT'S IT PROVIDER.

PROVIDE POWER FOR FIRE RATED MOTORIZED ROLL-DOWN COUNTER DOOR PER MANUFACTURER'S RECOMMENDATIONS. SEE COOKSEN MOTOR-OPERATED COUNTER DOOR (OR EQUAL), COLORCOTE FINISH;

10 PROVIDE POWER FOR INTERIOR DRINKING FOUNTAIN. REFER TO PLUMBING ENGINEERING DWGS. FOR SPECS.

13 PROVIDE DOOR BUZZER AND COMUNICATION DEVICE WITH CONDUIT TO MAIN GATE ENTRANCE

MDF ROOMS 1ST AND 2ND FLOORS — ALL EQUIPMENT TO BE MOUNTED ON BATHROOM SIDE OF ROOMS — PROVIDE 3/4" PLYWOOD BACKING ON WALL — RACKS BY OTHERS NEED 2 EA — 120V CIRCUITS WIT QUAD BOXES IN THESE ROOMS. PROVIDE 1—1/2" CONDUIT FROM 1ST FLOOR MDF TO 2ND FLOOR MDF. PROVIDE 1—1/2" CONDUIT FROM 1ST FLOOR MDF ROOM TO EXISTING BUILDING MDF.

MAGNOLIA 18220 SHERMAN

FD PLAN CHECK 12/14/2017

REV DESCRIPTION DATE

PLAN CHECK #1 6/14/2017

FD PLAN CHECK 10/31/2017




MAGNOLIA SCIENCE ACADEMY

18220 SHERMAN WAY, RESEDA, CA91335

DRAWING TITLE
FIRST FLOOR

POWER & SIGNAL PLAN 12/14/2017 AS NOTED

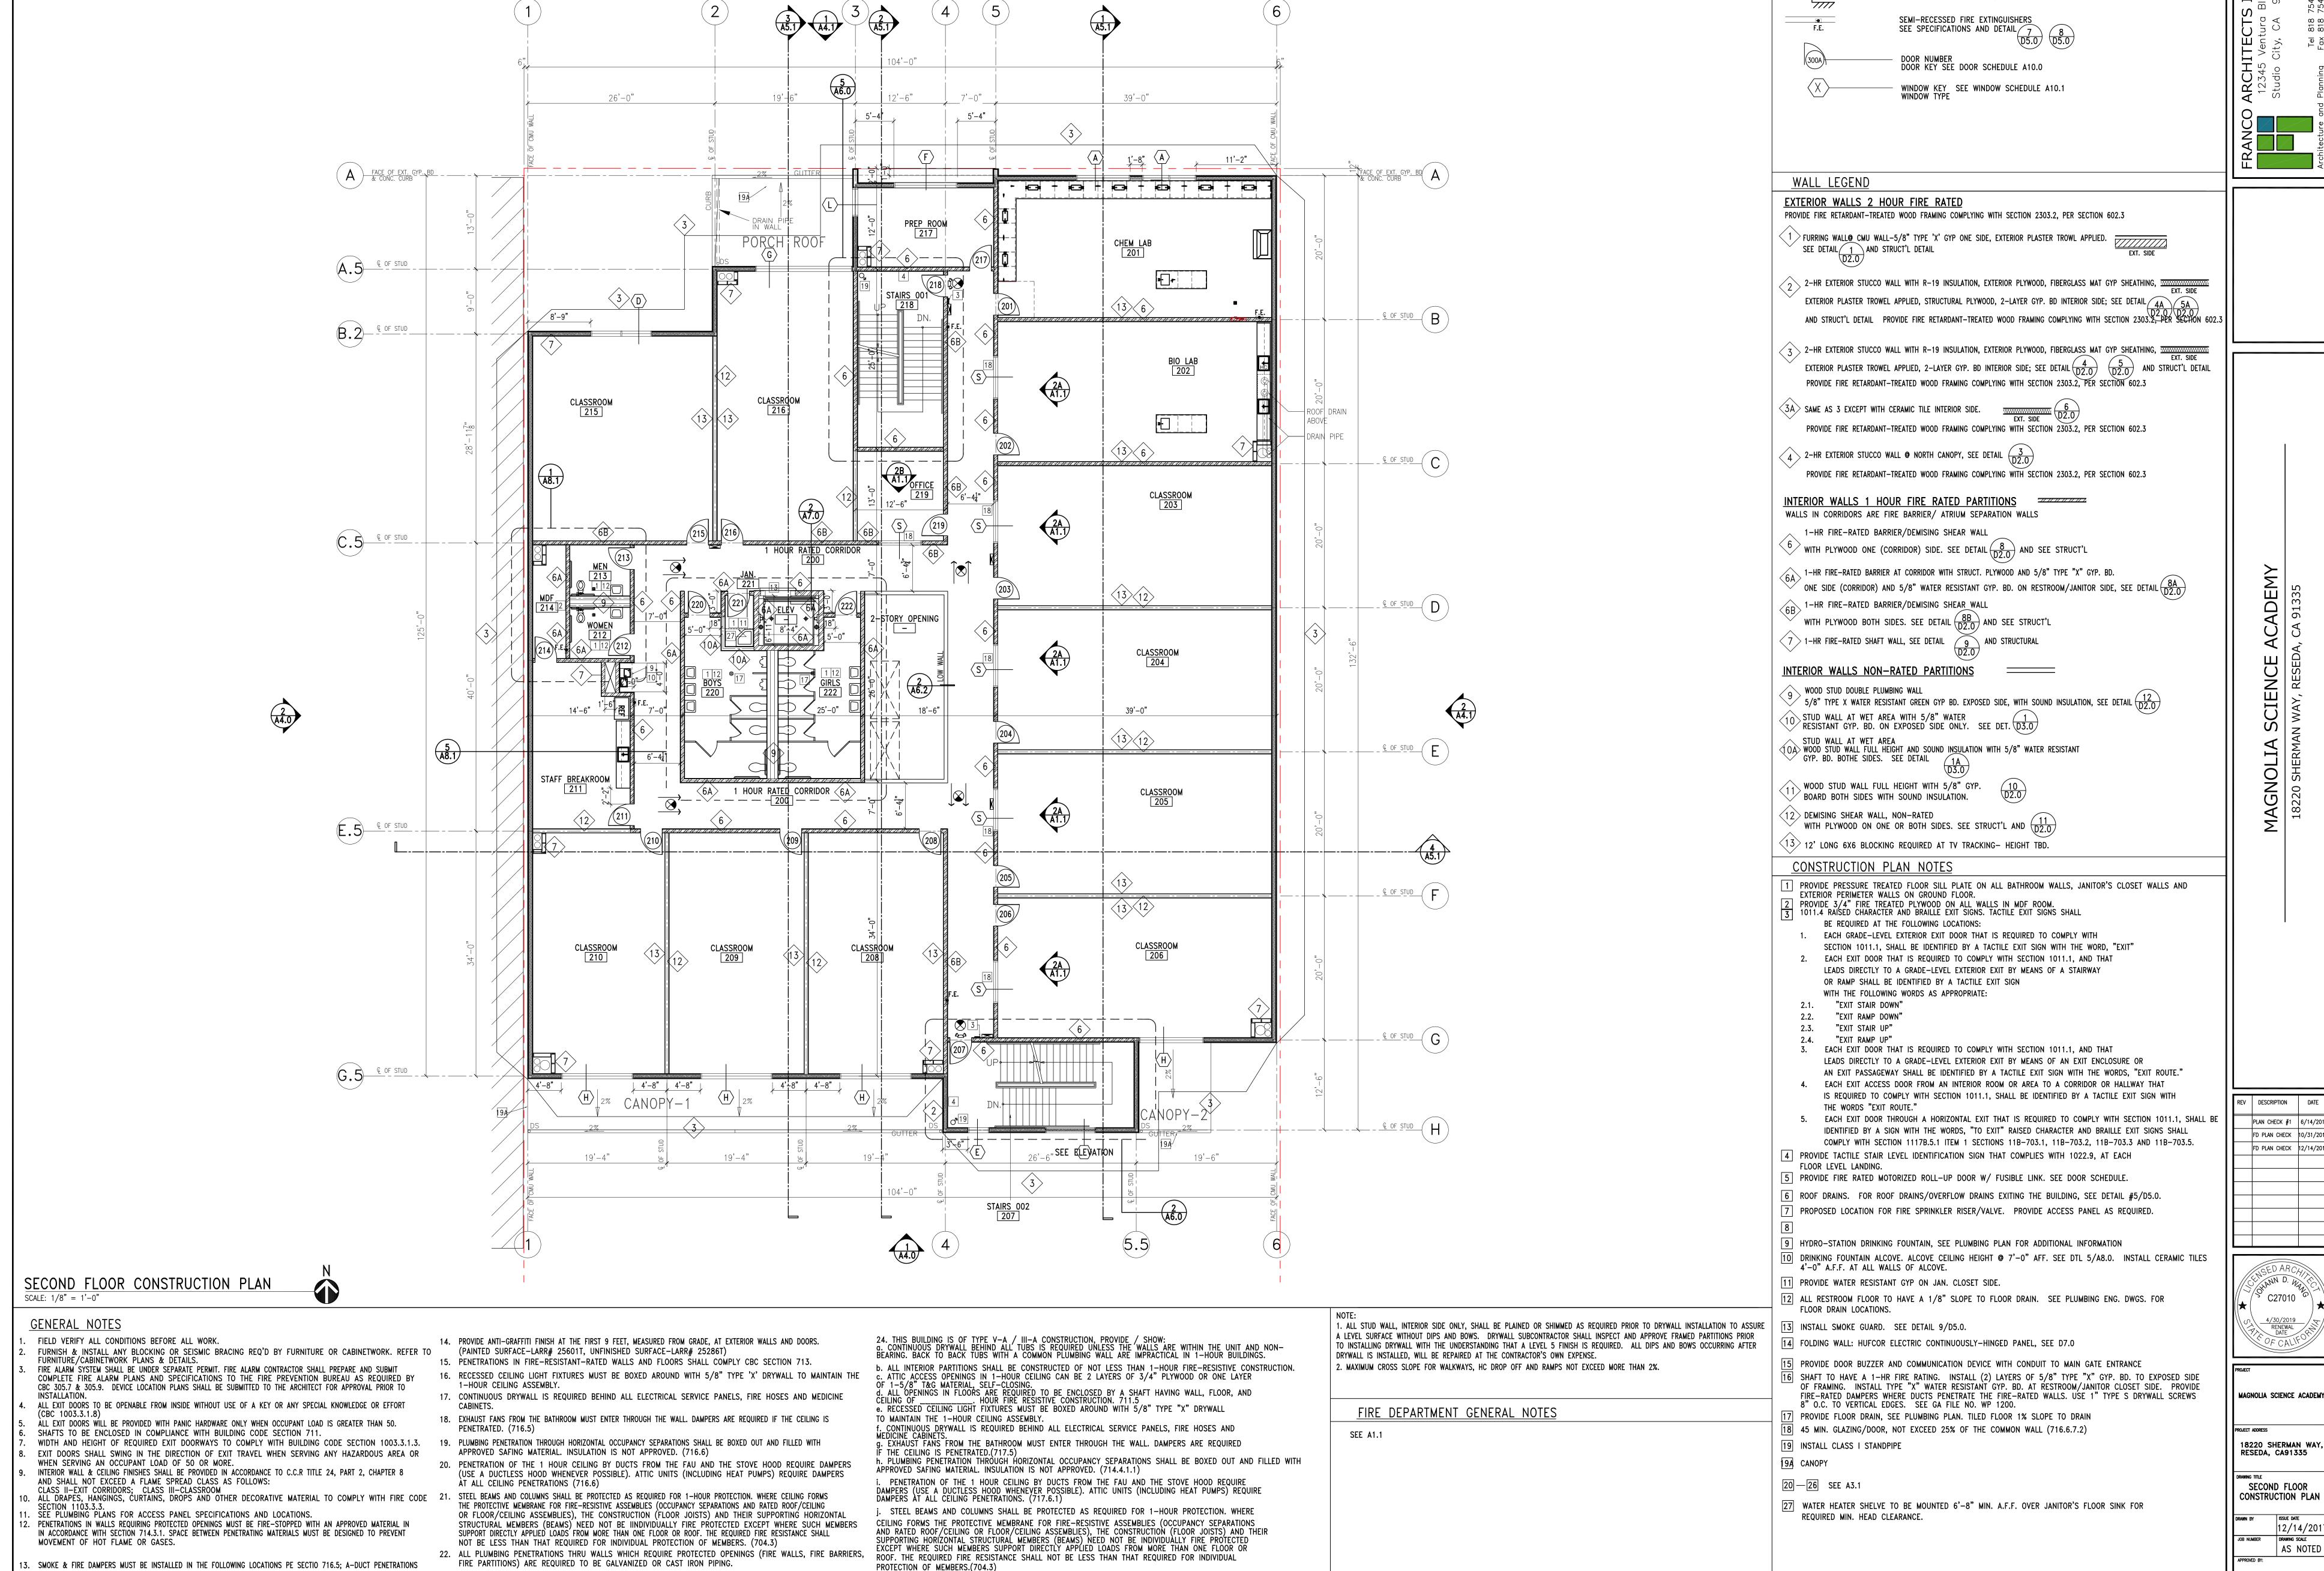

25. THIS BUILDING MUST BE EQUIPPED WITH AN AUTOMATIC FIRE EXTINGUISHING SYSTEM, COMPLYING WITH (NFPA-13/

NFPA-13R); THE SPRINKLER SYSTEM SHALL BE APPROVED BY PLUMBING DIV. PRIOR TO INSTALLATION. (903.2.7)

23. ALL BUILDING AND FACILITY ENTRANCES THAT ARE ACCESSIBLE TO AND USABLE BY PERSONS WITH DISABILITIES AND

AT EVERY MAJOR JUNCTION ALONG OR LEADING TO AN ACCESSIBLE ROUTE OF TRAVEL SHALL BE IDENTIFIED WITH A SIGN DISPLAYING THE INTERNATIONAL SYMBOL OF ACCESSIBILITY AND WITH ADDITIONAL DIRECTIONAL SIGNS TO BE VISIBLE TO PERSONS ALONG APPROACHING CIRCULATION PATHS. (1117B.5.8.1.2, 1127B.3)

OF AREA OR OCCUPANCY SEPARATION PASSING THROUGH WALLS WITH RATINGS OF TWO HOURS OR LESS; B-DUCTS

RESISTIVE ELEMENTS OF FIRE-RATED CORRIDOR WALLS. SEE MECHANICAL DRAWINGS FOR LOCATIONS.

PASSING THROUGH HORIZONTAL EXIT WALLS; C-DUCTS PENETRATING SHAFTS; D-DUCTS PENETRATING FIRE-

DESCRIPTION DATE PLAN CHECK #1 6/14/20 FD PLAN CHECK 10/31/20 FD PLAN CHECK 12/14/2017

MAGNOLIA SCIENCE ACADEMY

AS NOTED DRAWING NUMBER


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GENERAL NOTES 3


SYMBOLS LEGEND

FINISH FLOOR ELEVATION CHANGE

LEGEND AND NOTES

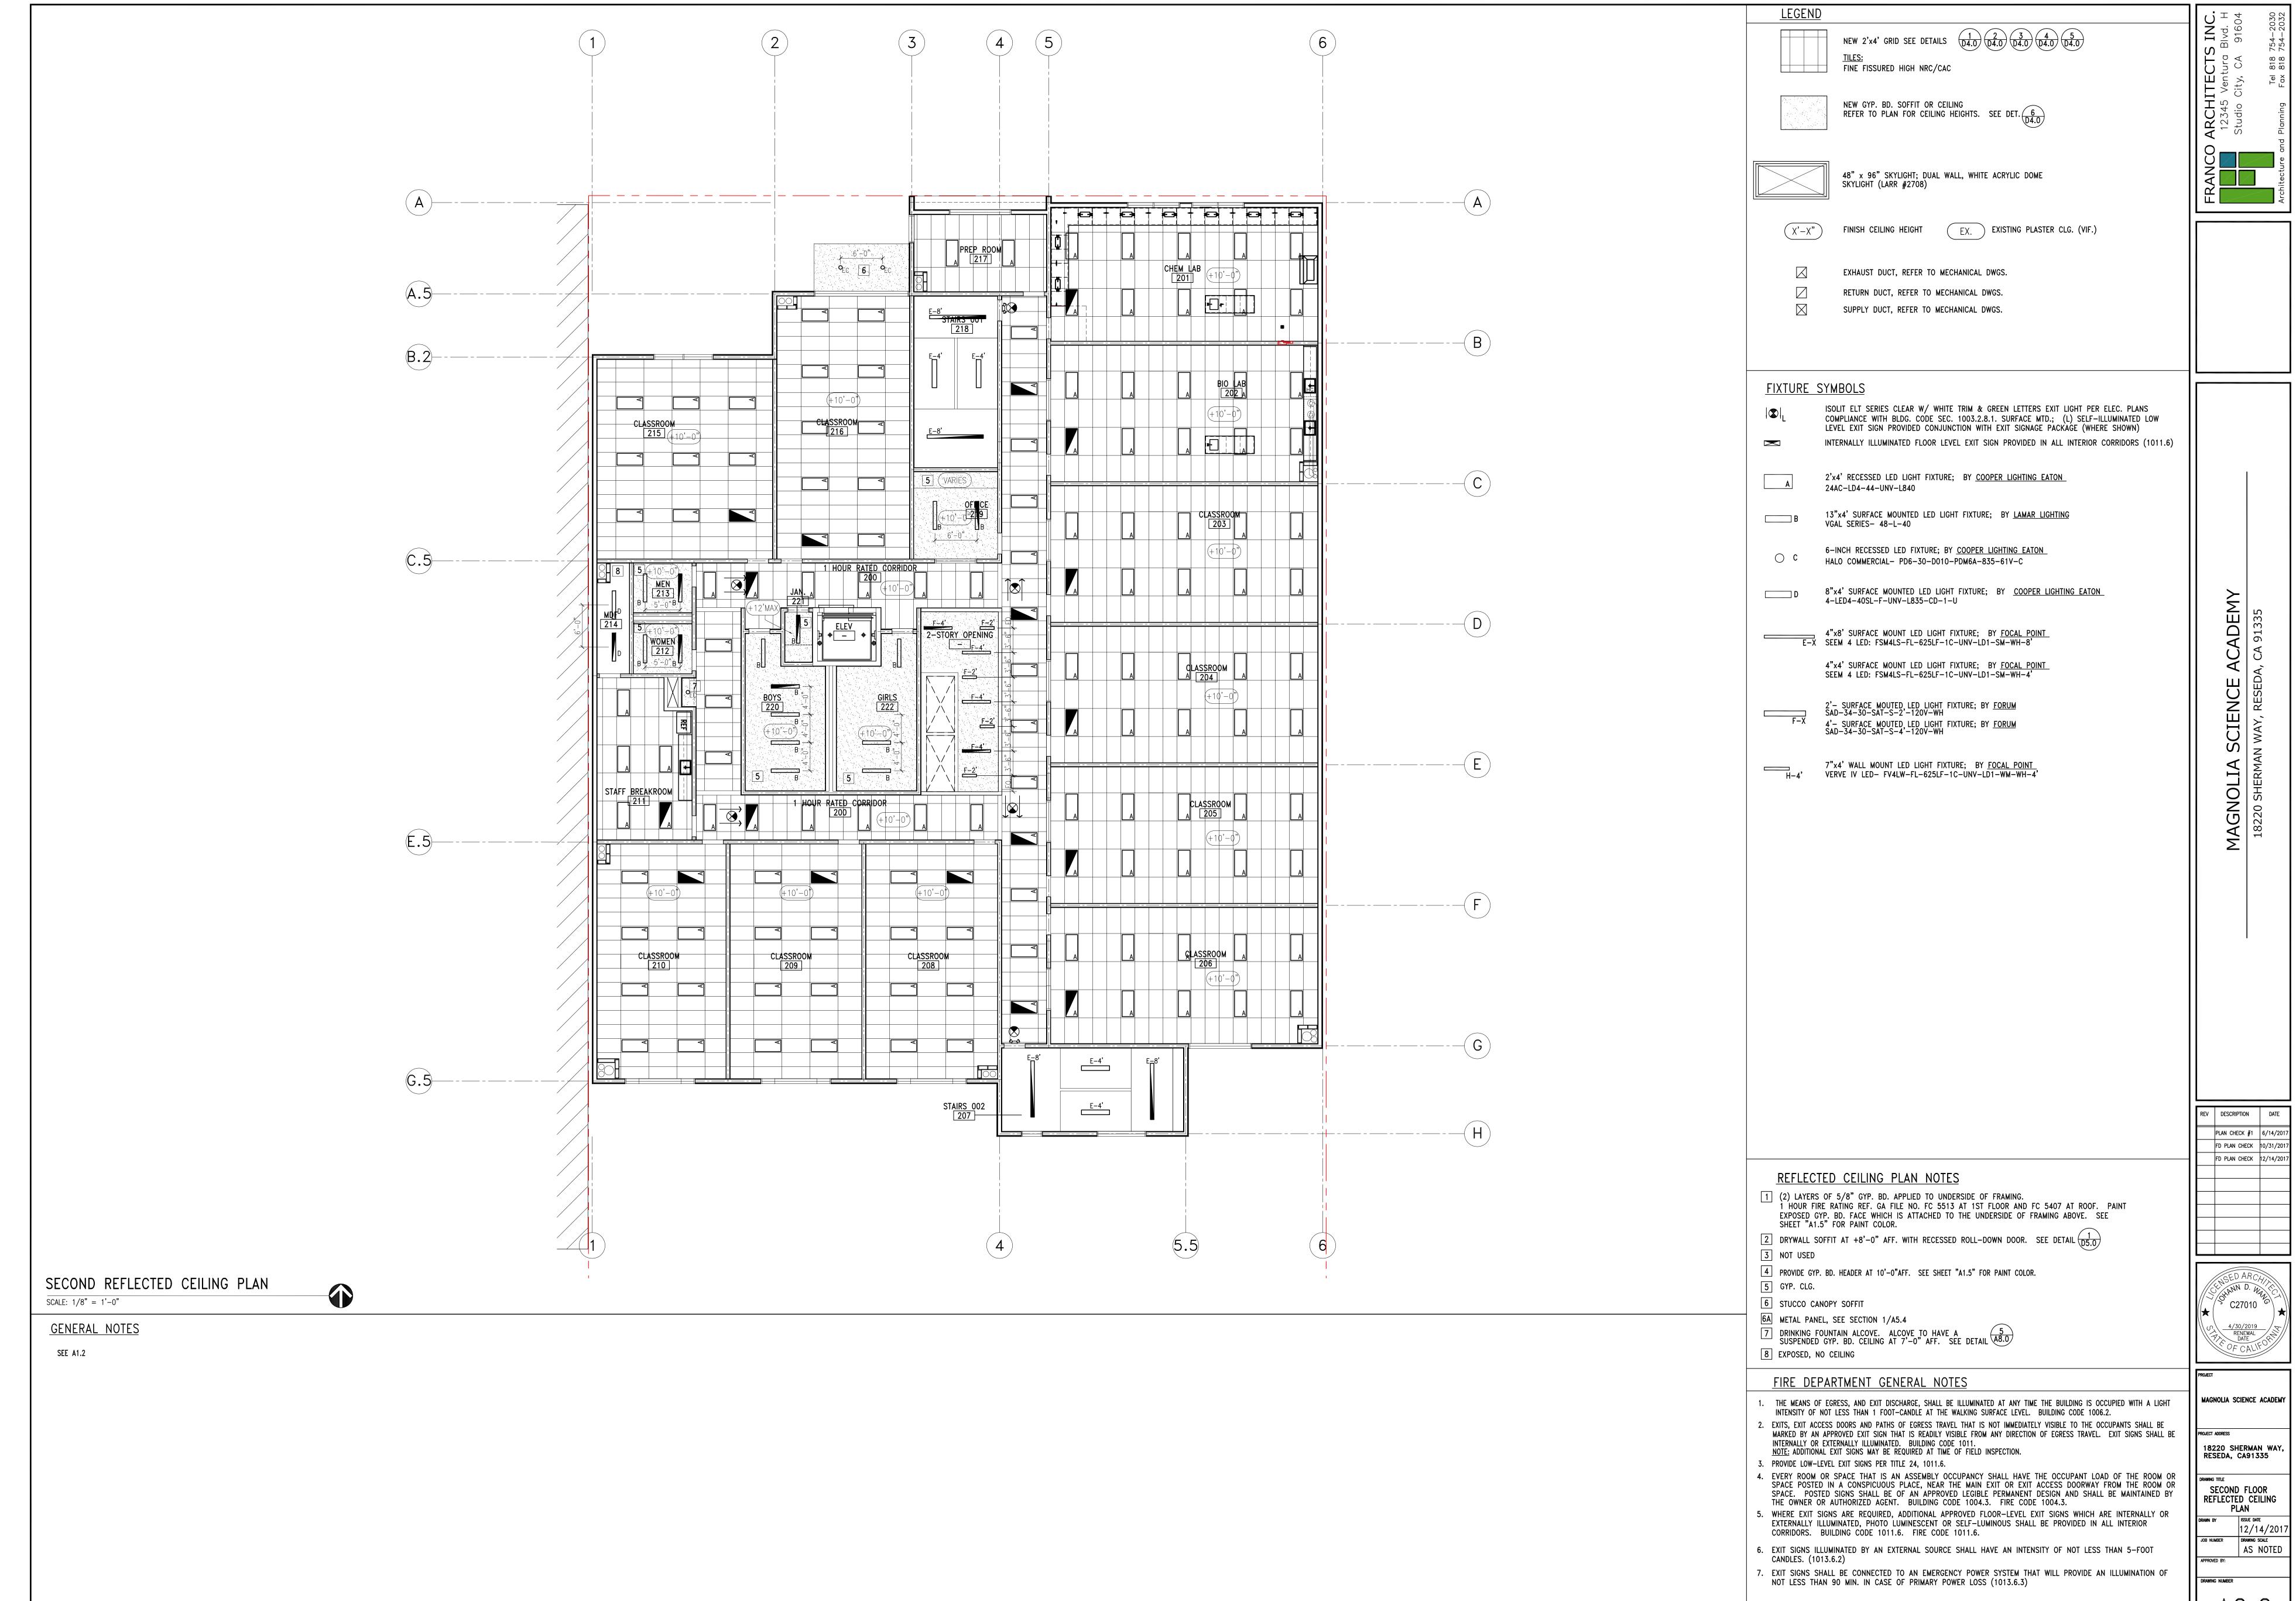

BID SET 03-07-18 LEGEND AND NOTES 2

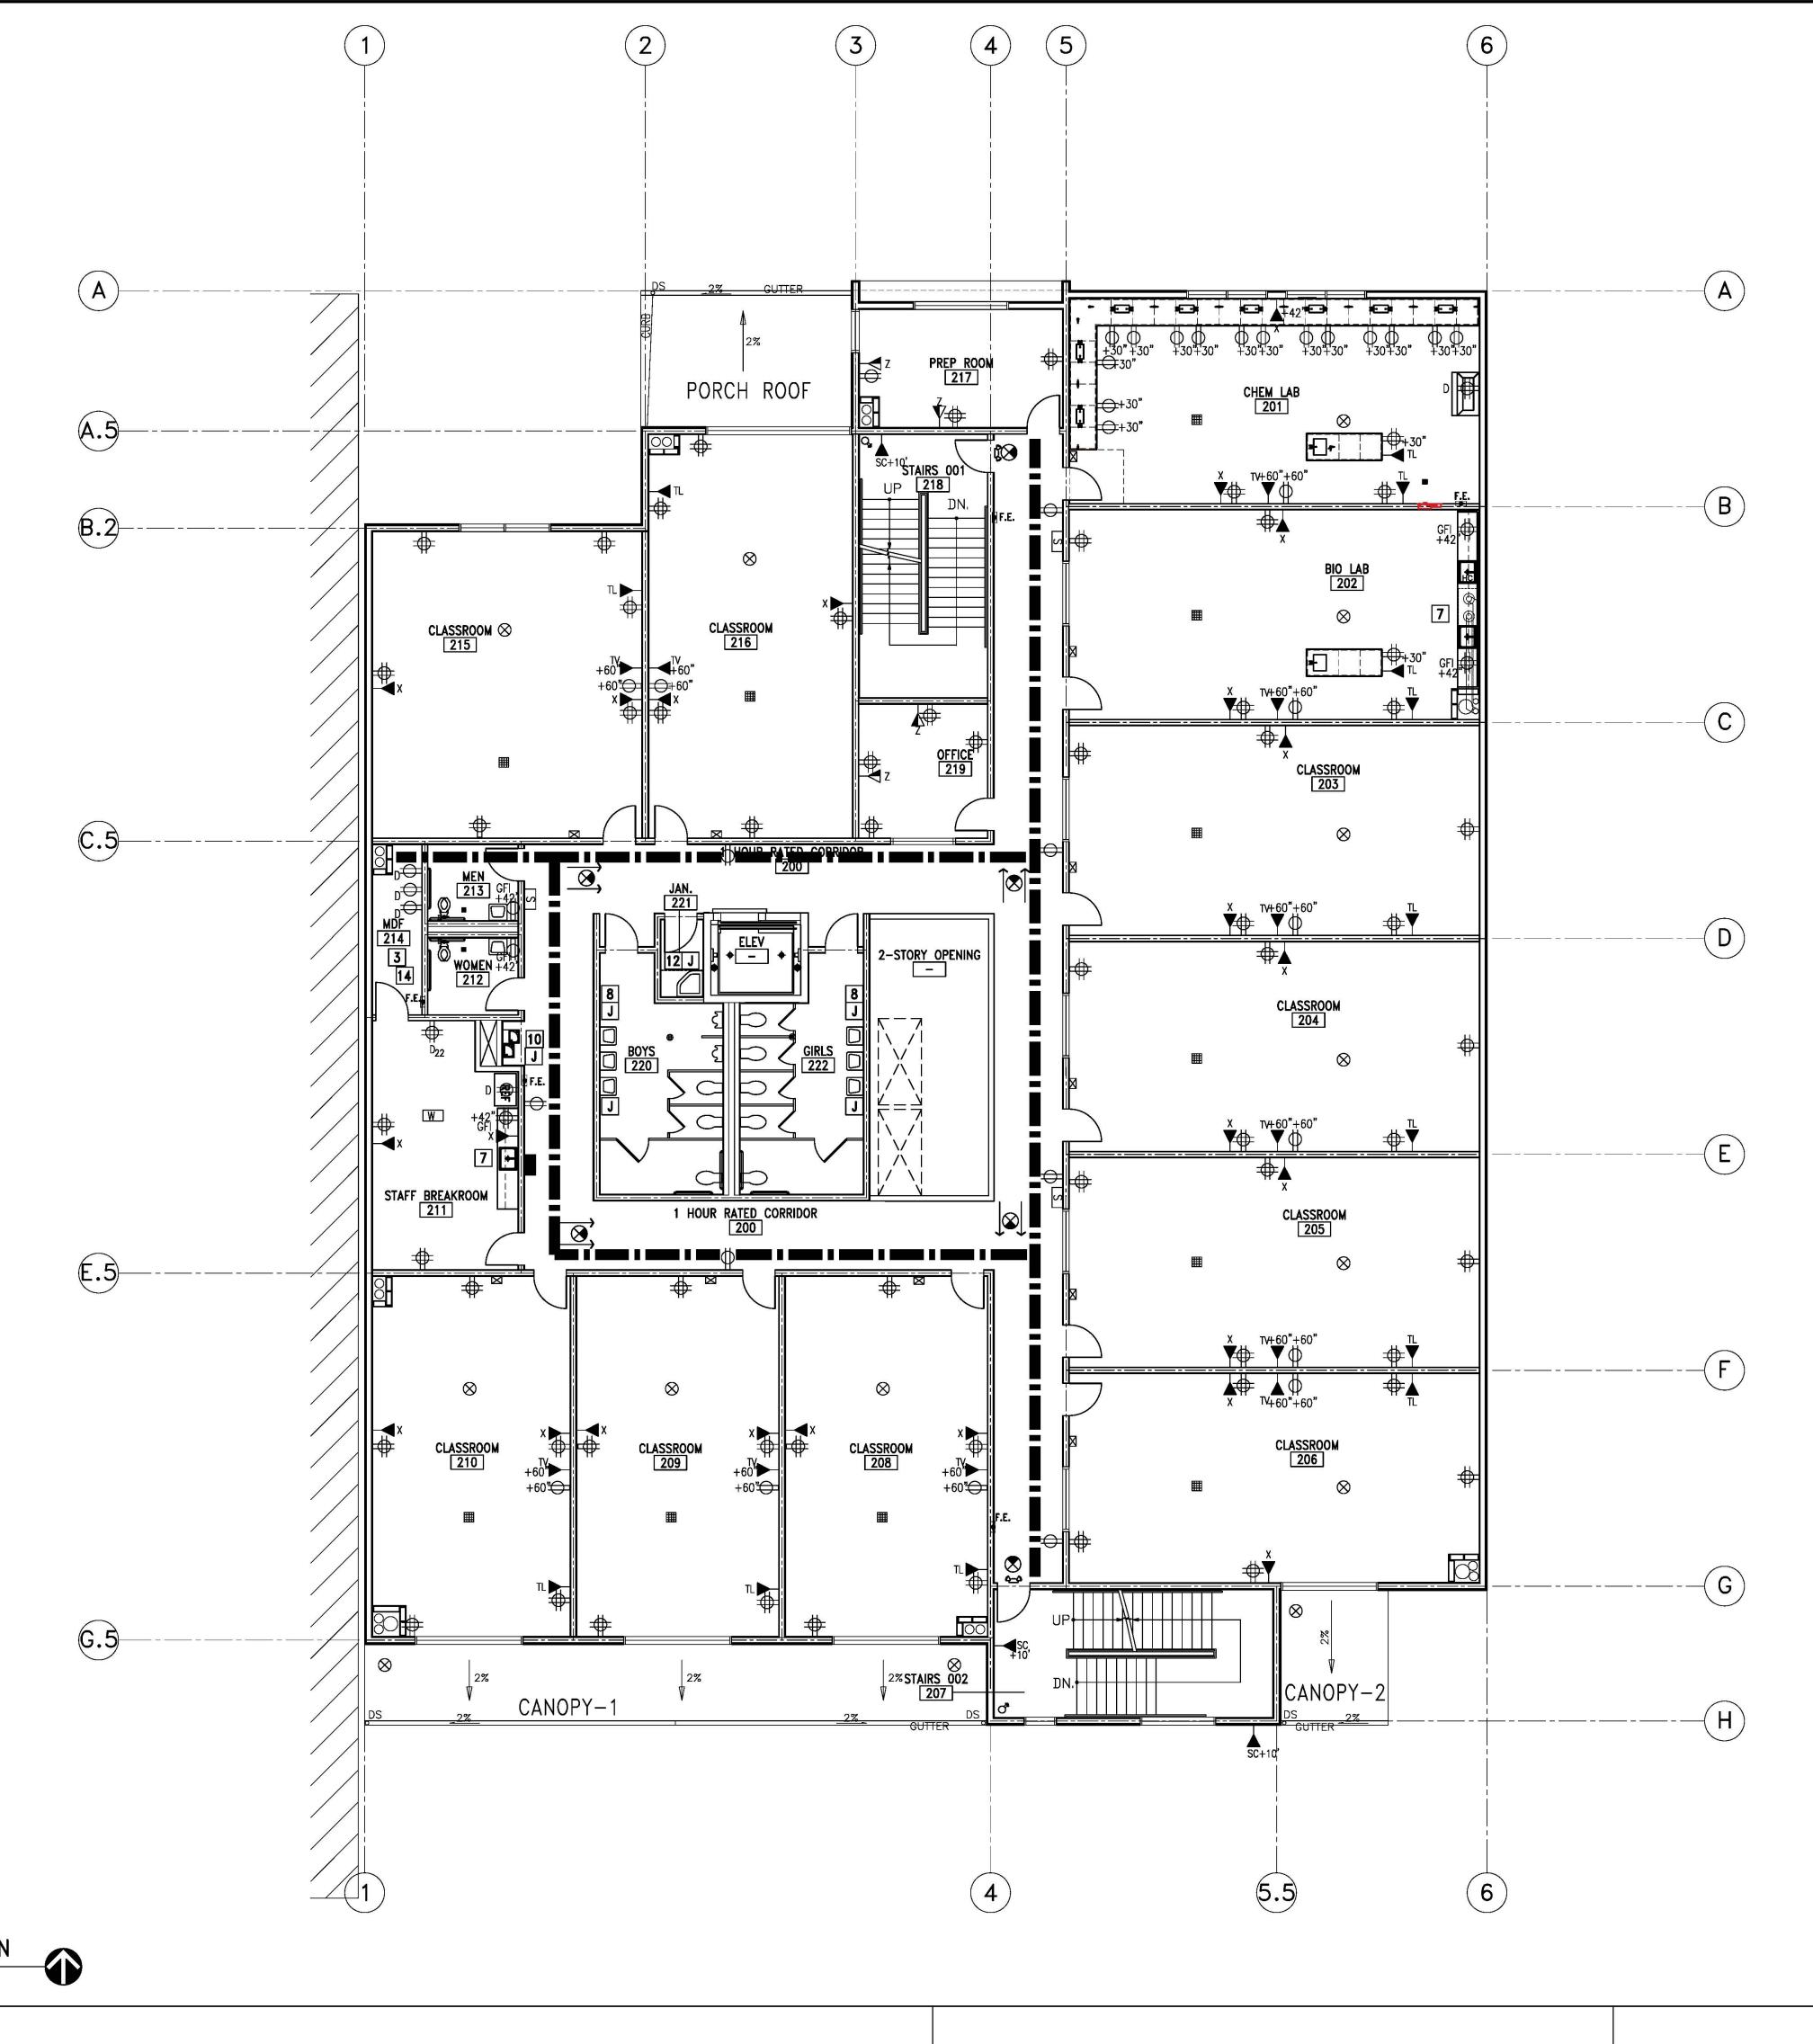

SECOND FLOOR POWER & SIGNAL PLAN SCALE: 1/8" = 1'-0"

GENERAL NOTES

- REFER TO ENGINEERED DWGS. FOR ELECTRICAL CIRCUITING. ALL ELECTRICAL DEVICES TO BE CIRCUITED AND INSTALLED TO COMPLY W/ LOCAL CODES A.D.A. TITLE III AND APPLICABLE STATE ENERGY REQUIREMENTS. SPECS. & ILLUSTRATIONS OF ELECT. DEVICES SPECIFIED BY THE ELECT. ENGINEERS SHALL BE SUBMITTED TO ARCHITECT FOR REVIEW & APPROVAL STAMP PRIOR TO PURCHASE OF MATERIALS & COMMENCEMENT OF WORK.
- CONDITIONS SHALL BE REPORTED TO ARCHITECT IMMEDIATELY, PRIOR TO INSTALLATION. CONTRACTOR SHALL FIELD VERIFY LOCATIONS OF ALL SWITCHES, OUTLETS & DEVICES PRIOR TO DRYWALL INSTALL.

OR EQUIPMENT: REFER TO ARCHITECT DWGS. IF NO DIMENSIONS ARE NOTED, CONTRACTOR SHALL SCALE

LOCATIONS OFF DWGS. & INSTALL ACCORDINGLY. ANY DISCREPANCIES BETWEEN NOTED DIMENSIONS AND FIELD


- ALL STD. COVERPLATES & DEVICES SHALL BE LEVITON DECORA SERIES U.O.N. EXCEPTION: EQUIPMENT REQUIRING NON-STANDARD RECEPTACLES. ALL STD. POWER & SIGNAL COVERPLATES, SWITCHES & DEVICE FINISHES SHALL BE WHITE U.O.N. WHERE
- INDICATED, CLEAN (ISOLATED) ELECTRICAL POWER TO BE DISTINGUISHED BY A GRAY RECEPTACLE. SEPARATE CIRCUITS TO BE DISTINGUISHED BY AN ORANGE RECEPTACLE. ALL WALL MTD. SIGNAL OUTLETS SHALL HAVE A J-BOX. COMMUNICATIONS & DATA SHALL PROVIDE COVERPLATES FOR ALL SIGNAL OUTLETS. CONTRACTOR SHALL PROVIDE COVERPLATES FOR ALL ELECTRICAL OUTLETS & SWITCHES.
- ALL CONDUIT AT WALL & FLOOR MOUNTED SIGNAL OUTLETS SHALL RECEIVE PULL WIRES INSTALLED BY THE CONTRACTOR.
- DO NOT INSTALL OUTLETS EITHER BACK TO BACK OR SIDE BY SIDE ON OPPOSITE SIDES OF SAME WALL EXCEPT WHERE SPECIFICALLY DIMENSIONED. SEPARATE ALL SUCH OUTLETS W/ONE STUD.
- ALL OUTLETS, SWITCHES & J-BOXES LOCATED IN ACOUSTICAL PARTITIONS SHALL RECEIVE BACKING EQUIVALENT TO "LOWRIES ELECTRICAL PADS." WHERE WALL MOUNTED OUTLETS ARE INDICATED SIDE BY SIDE, THE MAX. SEPARATION BETWEEN SUCH OUTLETS
- SHALL BE 6" CEN. TO CEN. U.O.N. 12. ALL WALL TEL. & ELECT. OUTLETS SHALL BE INSTALLED FROM BOTTOM OF RECEPTACLE BOX OR RECEPTACLE HOUSING TO 15" AFF. U.O.N. OUTLETS INSTALLED ABOVE MILLWORK TO BE INSTALLED VERTICALLY U.O.N. SEE 11/A0.3 13. ALL SWITCHES SHALL BE GANG PLATED, WHERE APPLICABLE.

- 14. SWITCHES & MOTION SENSORS (IF ANY) SHALL BE INSTALLED @ 42" A.F.F. TO CENTER AND AT 6" OFF DOOR
- 15. MOUNT SWITCHES & OUTLETS FORWARD TO FACE OF FINISHED BACK WALL LOCATIONS OF TILES, WALLS AND SPLASH. REFER TO FINISH AND/OR CABINET PLANS FOR LOCATIONS. 16. ALL ELECTRICAL ITEMS NOTED FOR INSTALL. IN CABINET WORK SHALL BE SUPPLIED, INSTALLED AND COORDINATED

BY THE CONTRACTOR, U.O.N.

- 17. COORDINATE, BID, FURNISH & INSTALL ALL CONDUIT RUNS, CONDUIT SLEEVES AND PLYWOOD BACKBOARD. COORDINATE WITH CLIENT AND/OR CLIENT'S COMMUNICATIONS & DATA VENDORS TO CONFIRM REQUIREMENTS.
- 18. COORDINATE, BID, FURNISH & INSTALL ALL SECURITY DEVICE J-BOXES, CONDUIT SLEEVES AND PLYWOOD BACKBOARDS. COORDINATE WITH CLIENT'S COMMUNICATIONS & DATA VENDORS TO CONFIRM REQUIREMENTS. 19. FIRE ALARM SYSTEM:
- A. NEW FIRE/LIFE SAFETY SYSTEM TO CONFORM TO CURRENT REQUIREMENTS. SYSTEM SHALL BE LEFT IN FIRST CLASS OPERATING CONDITION. COMPATIBLE W/ AND INTEGRATED INTO THE BLDG. ALARM CONTROL SYSTEM. B. FIRE ALARM SYSTEM SHALL CONSIST OF SMOKE DETECTORS, AUDIBLE & VISUAL (STROBE) ALARMS, AND MANUAL FIRE ALARM PULL STATIONS AS REQ'D BY STATE FIRE MARSHALL. C. SUBMIT DESIGN SPECS. AND DRAWINGS FOR ARCHITECT COORDINATION WITH ARCHITECTURAL DRAWINGS AND APPROVAL PRIOR TO PERMIT SUBMITTAL.
- D. PROVIDE AN APPROVED FIRE ALARM SYSTEM. SUBMIT PLANS TO AREA PRIOR TO INSTALLATION PER TITLE 24, 305.9 & FIRE CODE 1007.2.4. 20. ALL OPEN WIRING IN PLENUM AREAS TO BE PLENUM RATED.
- 21. PROVIDE DATA CONDUIT PER ELECTRICAL PLANS & PLANS PROVIDED BY THE OWNERS DATA VENDOR AS NOTED BUT NOT LIMITED TO THE FOLLOWING: PROVIDE CONDUIT TO OWNER PROVIDED WIRELESS ANTENNA.

PROVIDE CONDUIT HOMERUN FROM DATA DROPS TO COMM. DATA ROOM

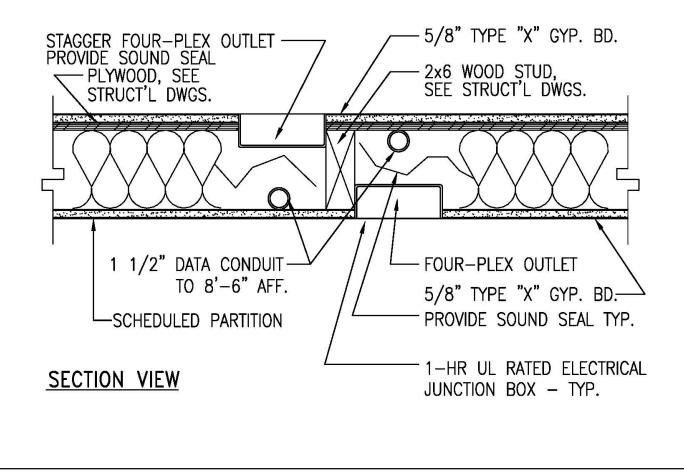

TYPICAL ELECTRICAL JUNCTION BOX & CONDUIT AT 1-HR WALL

WALL MOUNTED FOURPLEX POWER OUTLET

WALL MOUNTED DUPLEX POWER OUTLET

WALL MOUNTED FOURPLEX DATA OUTLET

SW = CEILING SPEAKER + WIDE AREA ACCESS POINT SPEAKER BY OTHERS - WIDE AREA ACCESS POINT IN CONDUIT

WALL MOUNTED DUPLEX DATA OUTLET

S = CEILING SPEAKER - PAIRED WITH WALL MOUNTED VOLUME CONTROL LOCATED NEXT TO ENTRANCE DOOR. SPEAKER AND VOLUME CONTROL BY OTHERS. REQUIRES DUPLEX BOX + 1/2" CONDUIT IN WALL

VOLUME CONTROL FOR SPEAKERS

S = WALL SPEAKER - SPEAKER BY OTHERS -REQUIRES DUPLEX BOX + CONDUIT TO CABLE TRAY (NO SEPARATE VOLUME CONTROL)

NOTE: THESE ENTRANCE DOORS WILL HAVE ELECTRONIC LOCKS, CONTROLS IN OFFICE.

VA = VIDEO ACCESS BOX - 3/4" CONDUIT TO CABLE TRAY TO OFFICE.

W = WIDE AREA ACCESS POINT - BOX AND CONDUIT TO CABLE TRAY

TEACHER LOCATION - VOIP + DATA QUAD BOX W/ 2EA 1.5" CONDUITS. ONE CONDUIT TO TV LOCATION IN ROOM - ONE CONDUIT TO CABLE TRAY TO MDF. PLUS ADJACENT POWER QUAD BOX, 120V

FELEVISION/MONITOR LOCATION - TV/MOUNTING BRACKET/CABLING BY OTHERS REQUIRES DATA QUAD BOX WITH 2 CONDUITS LOCATED ABOVE CEILING -ONE 1.5" CONDUIT TO TL AND ONE 3/4" CONDUIT TO CABLE TRAY TO MDF ALSO NEEDS ABOVE CEILING - DUPLEX POWER 120V

QUAD DATA BOX +3/4" CONDUIT TO CABLE TRAY TO MDF - MOUNT LOW ON WALL OR ABOVE LAB TABLES. CENTER ON WALL - NOTE: LOW WALL DATA BOX UNDER TV IN ADDITION TO ABOVE CEILING DATA BOX SERVING TV

DUPLEX DATA BOX + 3/4" CONDUIT TO CABLE TRAY TO MDF

SECURITY CAMERA - EXTERIOR CAMERAS MOUNTED 10 FT ABOVE GRADE AND BELOW CANOPY AND PORCH ROOF - QUAD BOX + 3/4" CONDUIT TO CABLE TRAY TO MDF. CORRIDOR CAMERAS NOT SHOWN; NO CONDUIT REQUIRED.

DEDICATED POWER CIRCUIT

DEDICATED POWER CIRCUIT FOR PRINTER- 22V POWER

GFI- GROUNDED OUTLET

DOOR BUZZER BY OTHERS- PROVIDE CONDUIT

X" ABOVE FINISHED FLOOR

JUNCTION BOX FOR ELECTRICAL POWERED HAND DRYER, 20A CIRCUIT; DRYER SHALL BE AMERICAN DRYER INC. EXTREMEAIR EXT7-SS.

EMERGENCY VOICE/ALARM COMMUNICATION SYSTEM

CABLE TRAY RUN - SMALL TO ACCOMMODATE LOW VOLTAGE ONLY CLOSE TO WALL, ABOVE T-BAR CEILING

ELECTRONIC DOOR LOCKS AT FRONT AND REAR ENTRANCES.


GENERAL DIRECTION: LOW VOLTAGE DEVICES AND WIRING TO BE BY OTHERS. BY OTHERS DEVICES INCLUDE: MDF EQUIPMENT UPS AND SERVER RACKS, CAT 5-6 WIRING AND HDTV CABLES, COVER PLATES, CEILING AND WALL SPEAKERS, SPEAKER VOLUME CONTROL, FELEVISION MONITORS, TV MOUNTING BRACKETS, INDOOR AND OUTDOOR SECURITY CAMERAS AND MOUNTING BRACKETS, AND VIDEO ACCESS PANELS. DEVICES BY CONTRACTOR INCLUDE:

POWER AND SIGNAL PLAN NOTES

- 1 IN ALL THE CLASSROOMS, AT EACH FOURPLEX OUTLETS PROVIDE A 1-1/2" CONDUIT FOR DATA.
- 2 IN ALL THE CLASSROOMS, PROVIDE A DEDICATED CIRCUIT FOR EVERY TWO FOURPLEX OUTLETS.
- 3 MDF ROOM: PROVIDE 3/4" FIRE TREATED PLYWOOD ON RESTROOM SIDE WALLS; PROVIDE (3) DEDICATED 20A DUPLEX RECEPTACLES, EACH ON A SEPARATE CIRCUIT. A DEDICATED 1.5 TON AC UNIT TO BE PROVIDED FOR THIS ROOM. CONTRACTOR TO COORDINATE AND CONFIRM ELECTRICAL REQUIREMENTS WITH CLIENT'S IT PROVIDER.
- PROVIDE POWER FOR FIRE RATED MOTORIZED ROLL-DOWN COUNTER DOOR PER MANUFACTURER'S RECOMMENDATIONS. SEE COOKSEN MOTOR-OPERATED COUNTER DOOR (OR EQUAL), COLORCOTE FINISH; BETWEEN JAMB MOUNTED; FEATHEREDGE. SEE 1
- 5 LOCATE FIRE ALARM CONTROL PANEL IN ELECTRICAL ROOM
- 6 PROVIDE LOCKABLE COVER PLATES FOR ALL EXTERIOR OUTLETS. WATER PROOF
- PROVIDE POWER FOR INSTA-HOT WATER HEATER AND GARBAGE DISPOSAL. REFER TO PLUMBING PLANS FOR SPECIFICATION.
- 8 ELECTRIC POWERED HAND DRYER.
- 9 NOT USED 10 PROVIDE POWER FOR INTERIOR DRINKING FOUNTAIN. REFER TO PLUMBING ENGINEERING DWGS. FOR SPECS.
- 11 PROVIDE DEDICATED ELECTRICAL OUTLET FOR COPIER.
- 12 PROVIDE POWER/CONNECTION FOR HOT WATER HEATER WITHIN JANITOR'S CLOSET. REFER TO PLUMBING ENGINEERING DWGS. FOR SPECS.
- 13 PROVIDE DOOR BUZZER AND COMUNICATION DEVICE WITH CONDUIT TO MAIN GATE ENTRANCE
- MDF ROOMS 1ST AND 2ND FLOORS ALL EQUIPMENT TO BE MOUNTED ON BATHROOM SIDE OF ROOMS PROVIDE 3/4" PLYWOOD BACKING ON WALL RACKS BY OTHERS NEED 2 EA 120V CIRCUITS WIT QUAD BOXES IN THESE ROOMS. PROVIDE 1-1/2" CONDUIT FROM 1ST FLOOR MDF TO 2ND FLOOR MDF. PROVIDE 1-1/2" CONDUIT FROM 1ST FLOOR MDF ROOM TO EXISTING BUILDING MDF.

FIRE DEPARTMENT GENERAL NOTES

THE POWER SUPPLY FOR MEANS OF EGRESS ILLUMINATION SHALL NORMALLY BE PROVIDED BY THE PREMISES ELECTRICAL SUPPLY. IN THE EVENT OF POWER SUPPLY FAILURE, THE EMERGENCY POWER SYSTEM SHALL PROVIDE POWER FOR A DURATION OF NOT LESS THAN 90 MINUTES AND SHALL CONSIST OF STORAGE BATTERIES, UNIT EQUIPMENT OR AN ON-SITE GENERATOR. BUILDING CODE 1006.3

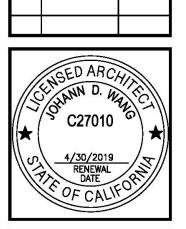

DESCRIPTION DATE

PLAN CHECK #1 6/14/2017 FD PLAN CHECK 10/31/2017 FD PLAN CHECK 12/14/2017

MAGNOLIA 18220 SHERMAI


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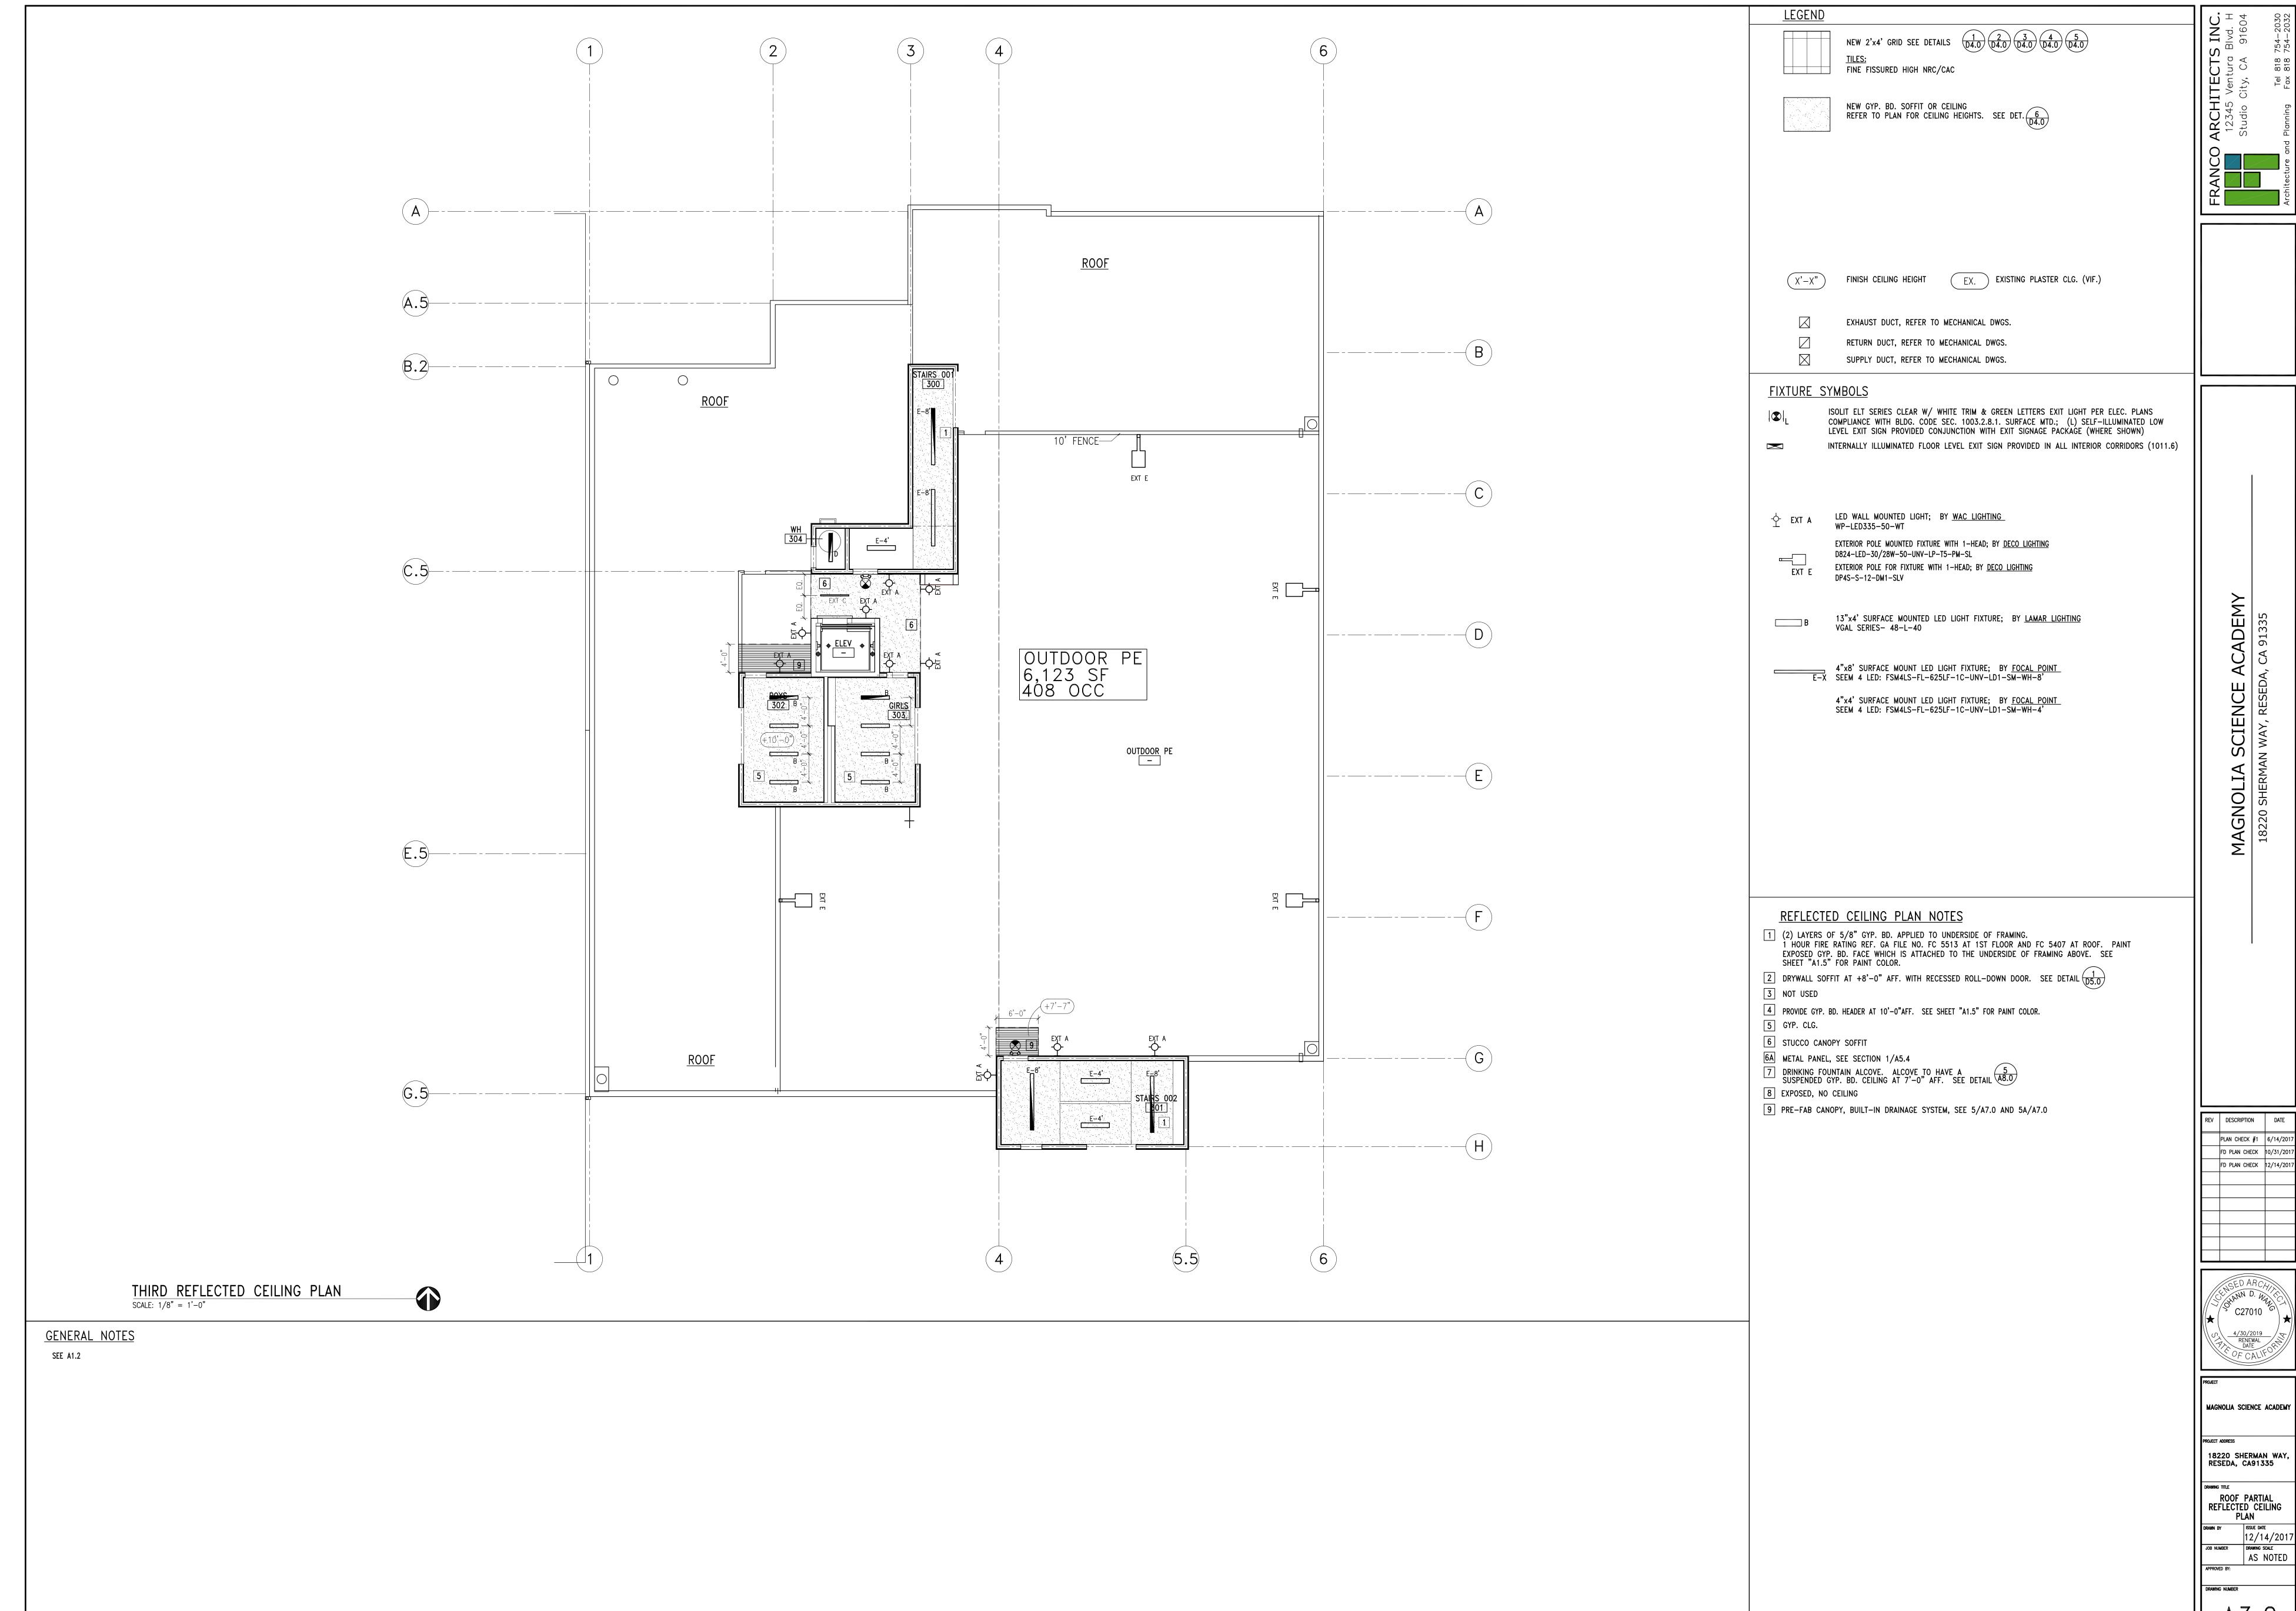
18220 SHERMAN WAY

RESEDA, CA91335

POWER & SIGNAL ISSUE DATE 12/14/201

AS NOTED DRAWING NUMBER



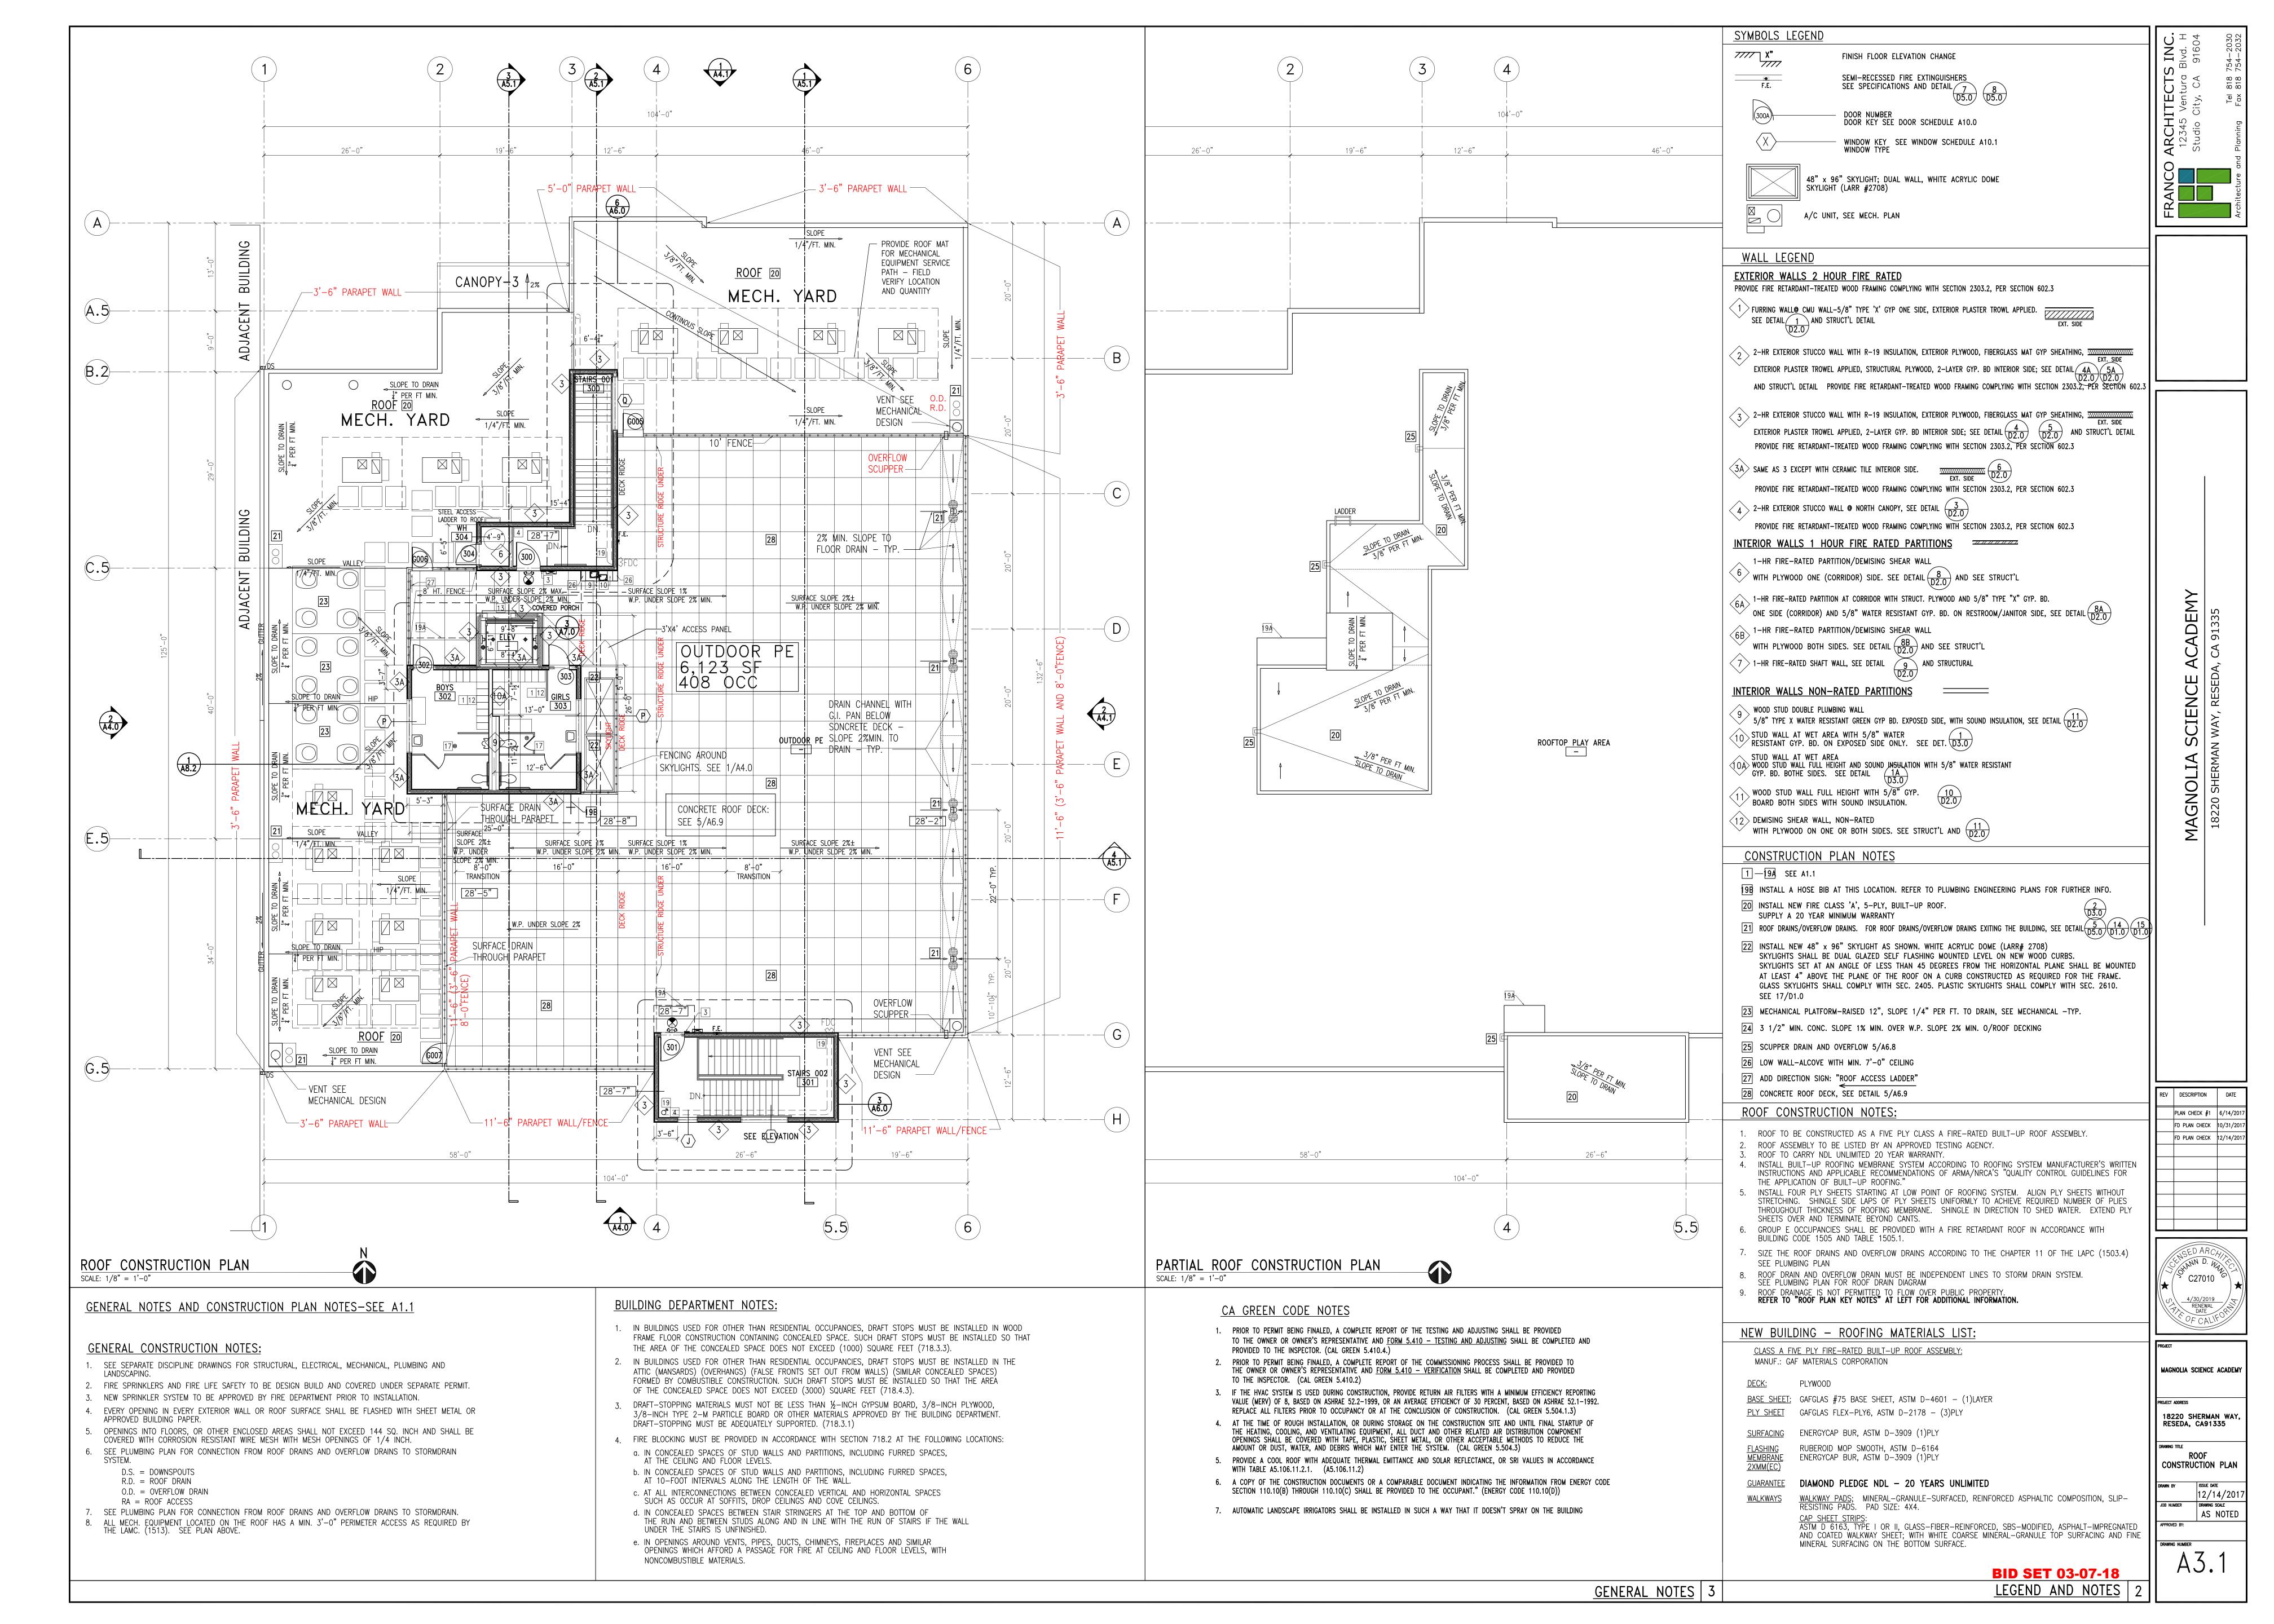

BID SET 03-07-18



1 IN ALL THE CLASSROOMS, AT EACH FOURPLEX OUTLETS PROVIDE A 1-1/2" CONDUIT FOR DATA.

WALL MOUNTED FOURPLEX POWER OUTLET

WALL MOUNTED DUPLEX POWER OUTLET

WALL MOUNTED FOURPLEX DATA OUTLET

WALL MOUNTED DUPLEX DATA OUTLET

SW = CEILING SPEAKER + WIDE AREA ACCESS POINT

SPEAKER BY OTHERS - WIDE AREA ACCESS POINT IN CONDUIT

- 2 IN ALL THE CLASSROOMS, PROVIDE A DEDICATED CIRCUIT FOR EVERY TWO FOURPLEX OUTLETS.
- MDF ROOM: PROVIDE 3/4" FIRE TREATED PLYWOOD ON RESTROOM SIDE WALLS; PROVIDE (3) DEDICATED 20A DUPLEX RECEPTACLES, EACH ON A SEPARATE CIRCUIT. A DEDICATED 1.5 TON AC UNIT TO BE PROVIDED FOR THIS ROOM. CONTRACTOR TO COORDINATE AND CONFIRM ELECTRICAL REQUIREMENTS WITH CLIENT'S IT PROVIDER.

LOW VOLTAGE DEVICES AND WIRING TO BE BY OTHERS. BY OTHERS

ELECTRONIC DOOR LOCKS AT FRONT AND REAR ENTRANCES.

DEVICES INCLUDE: MDF EQUIPMENT UPS AND SERVER RACKS, CAT 5-6 WIRING AND HDTV CABLES, COVER PLATES, CEILING AND WALL SPEAKERS, SPEAKER VOLUME CONTROL,

TELEVISION MONITORS, TV MOUNTING BRACKETS, INDOOR AND OUTDOOR SECURITY CAMERAS


AND MOUNTING BRACKETS, AND VIDEO ACCESS PANELS. DEVICES BY CONTRACTOR INCLUDE:

- PROVIDE POWER FOR FIRE RATED MOTORIZED ROLL-DOWN COUNTER DOOR PER MANUFACTURER'S RECOMMENDATIONS. SEE COOKSEN MOTOR-OPERATED COUNTER DOOR (OR EQUAL), COLORCOTE FINISH; BETWEEN JAMB MOUNTED; FEATHEREDGE. SEE 1

 D5.0
- 5 LOCATE FIRE ALARM CONTROL PANEL IN ELECTRICAL ROOM
- 6 PROVIDE LOCKABLE COVER PLATES FOR ALL EXTERIOR OUTLETS. WATER PROOF
- PROVIDE POWER FOR INSTA-HOT WATER HEATER AND GARBAGE DISPOSAL. REFER TO PLUMBING PLANS FOR SPECIFICATION.
- 8 ELECTRIC POWERED HAND DRYER.
- 9 NOT USED

<u>4</u>

- 10 PROVIDE POWER FOR INTERIOR DRINKING FOUNTAIN. REFER TO PLUMBING ENGINEERING DWGS. FOR SPECS.
- 11 PROVIDE DEDICATED ELECTRICAL OUTLET FOR COPIER.
- PROVIDE POWER/CONNECTION FOR HOT WATER HEATER WITHIN JANITOR'S CLOSET. REFER TO PLUMBING ENGINEERING DWGS. FOR SPECS.
- 13 PROVIDE DOOR BUZZER AND COMUNICATION DEVICE WITH CONDUIT TO MAIN GATE ENTRANCE
- 14 SOLAR ZONE AREA: 1,571 SF (>15% OF 10,300 TOTAL ROOF AREA)

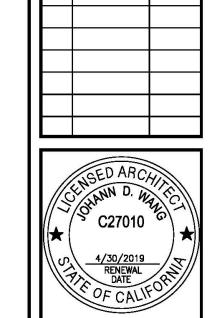

REV DESCRIPTION DATE

PLAN CHECK #1 6/14/2017

FD PLAN CHECK 10/31/2017

FD PLAN CHECK 12/14/2017

MAGNOLIA SCIENCE ACADEMY

18220 SHERMAN WAY, RESEDA, CA91335

DRAWING TILE

ROOF
POWER & SIGNAL
PLAN


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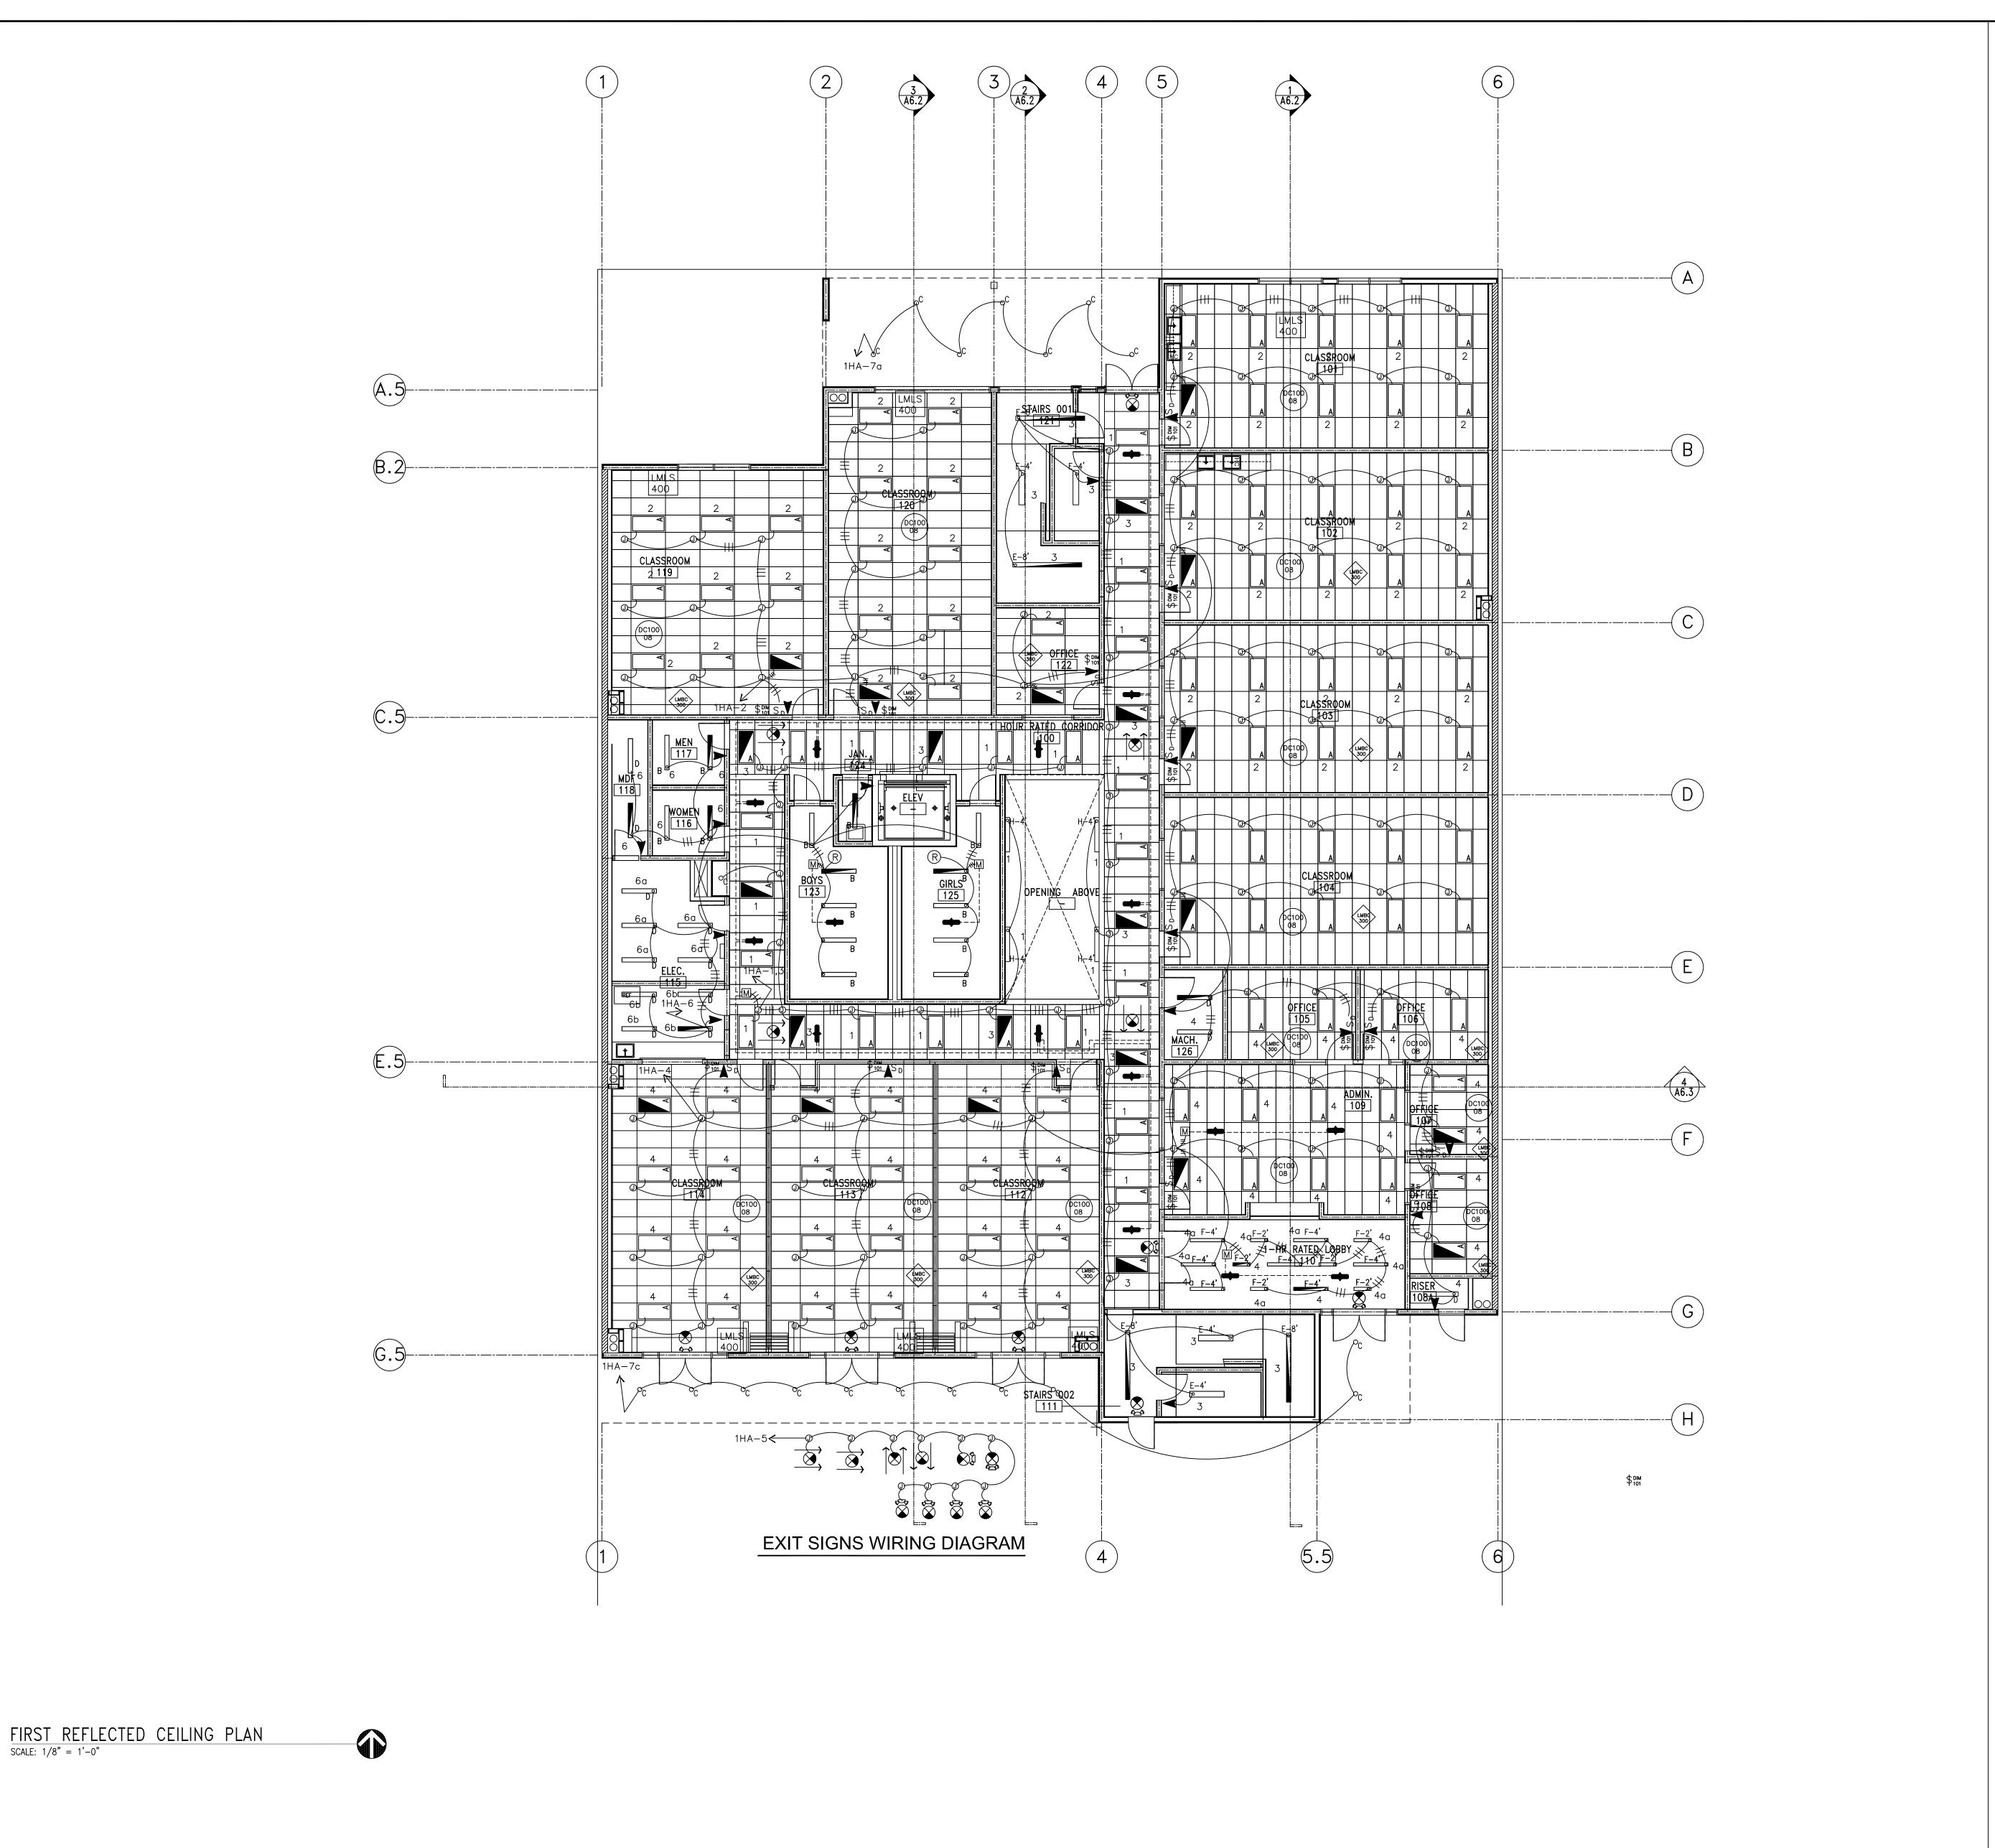
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A3.3



ROOF POWER & SIGNAL PLAN

SCALE: 1/8" = 1'-0"

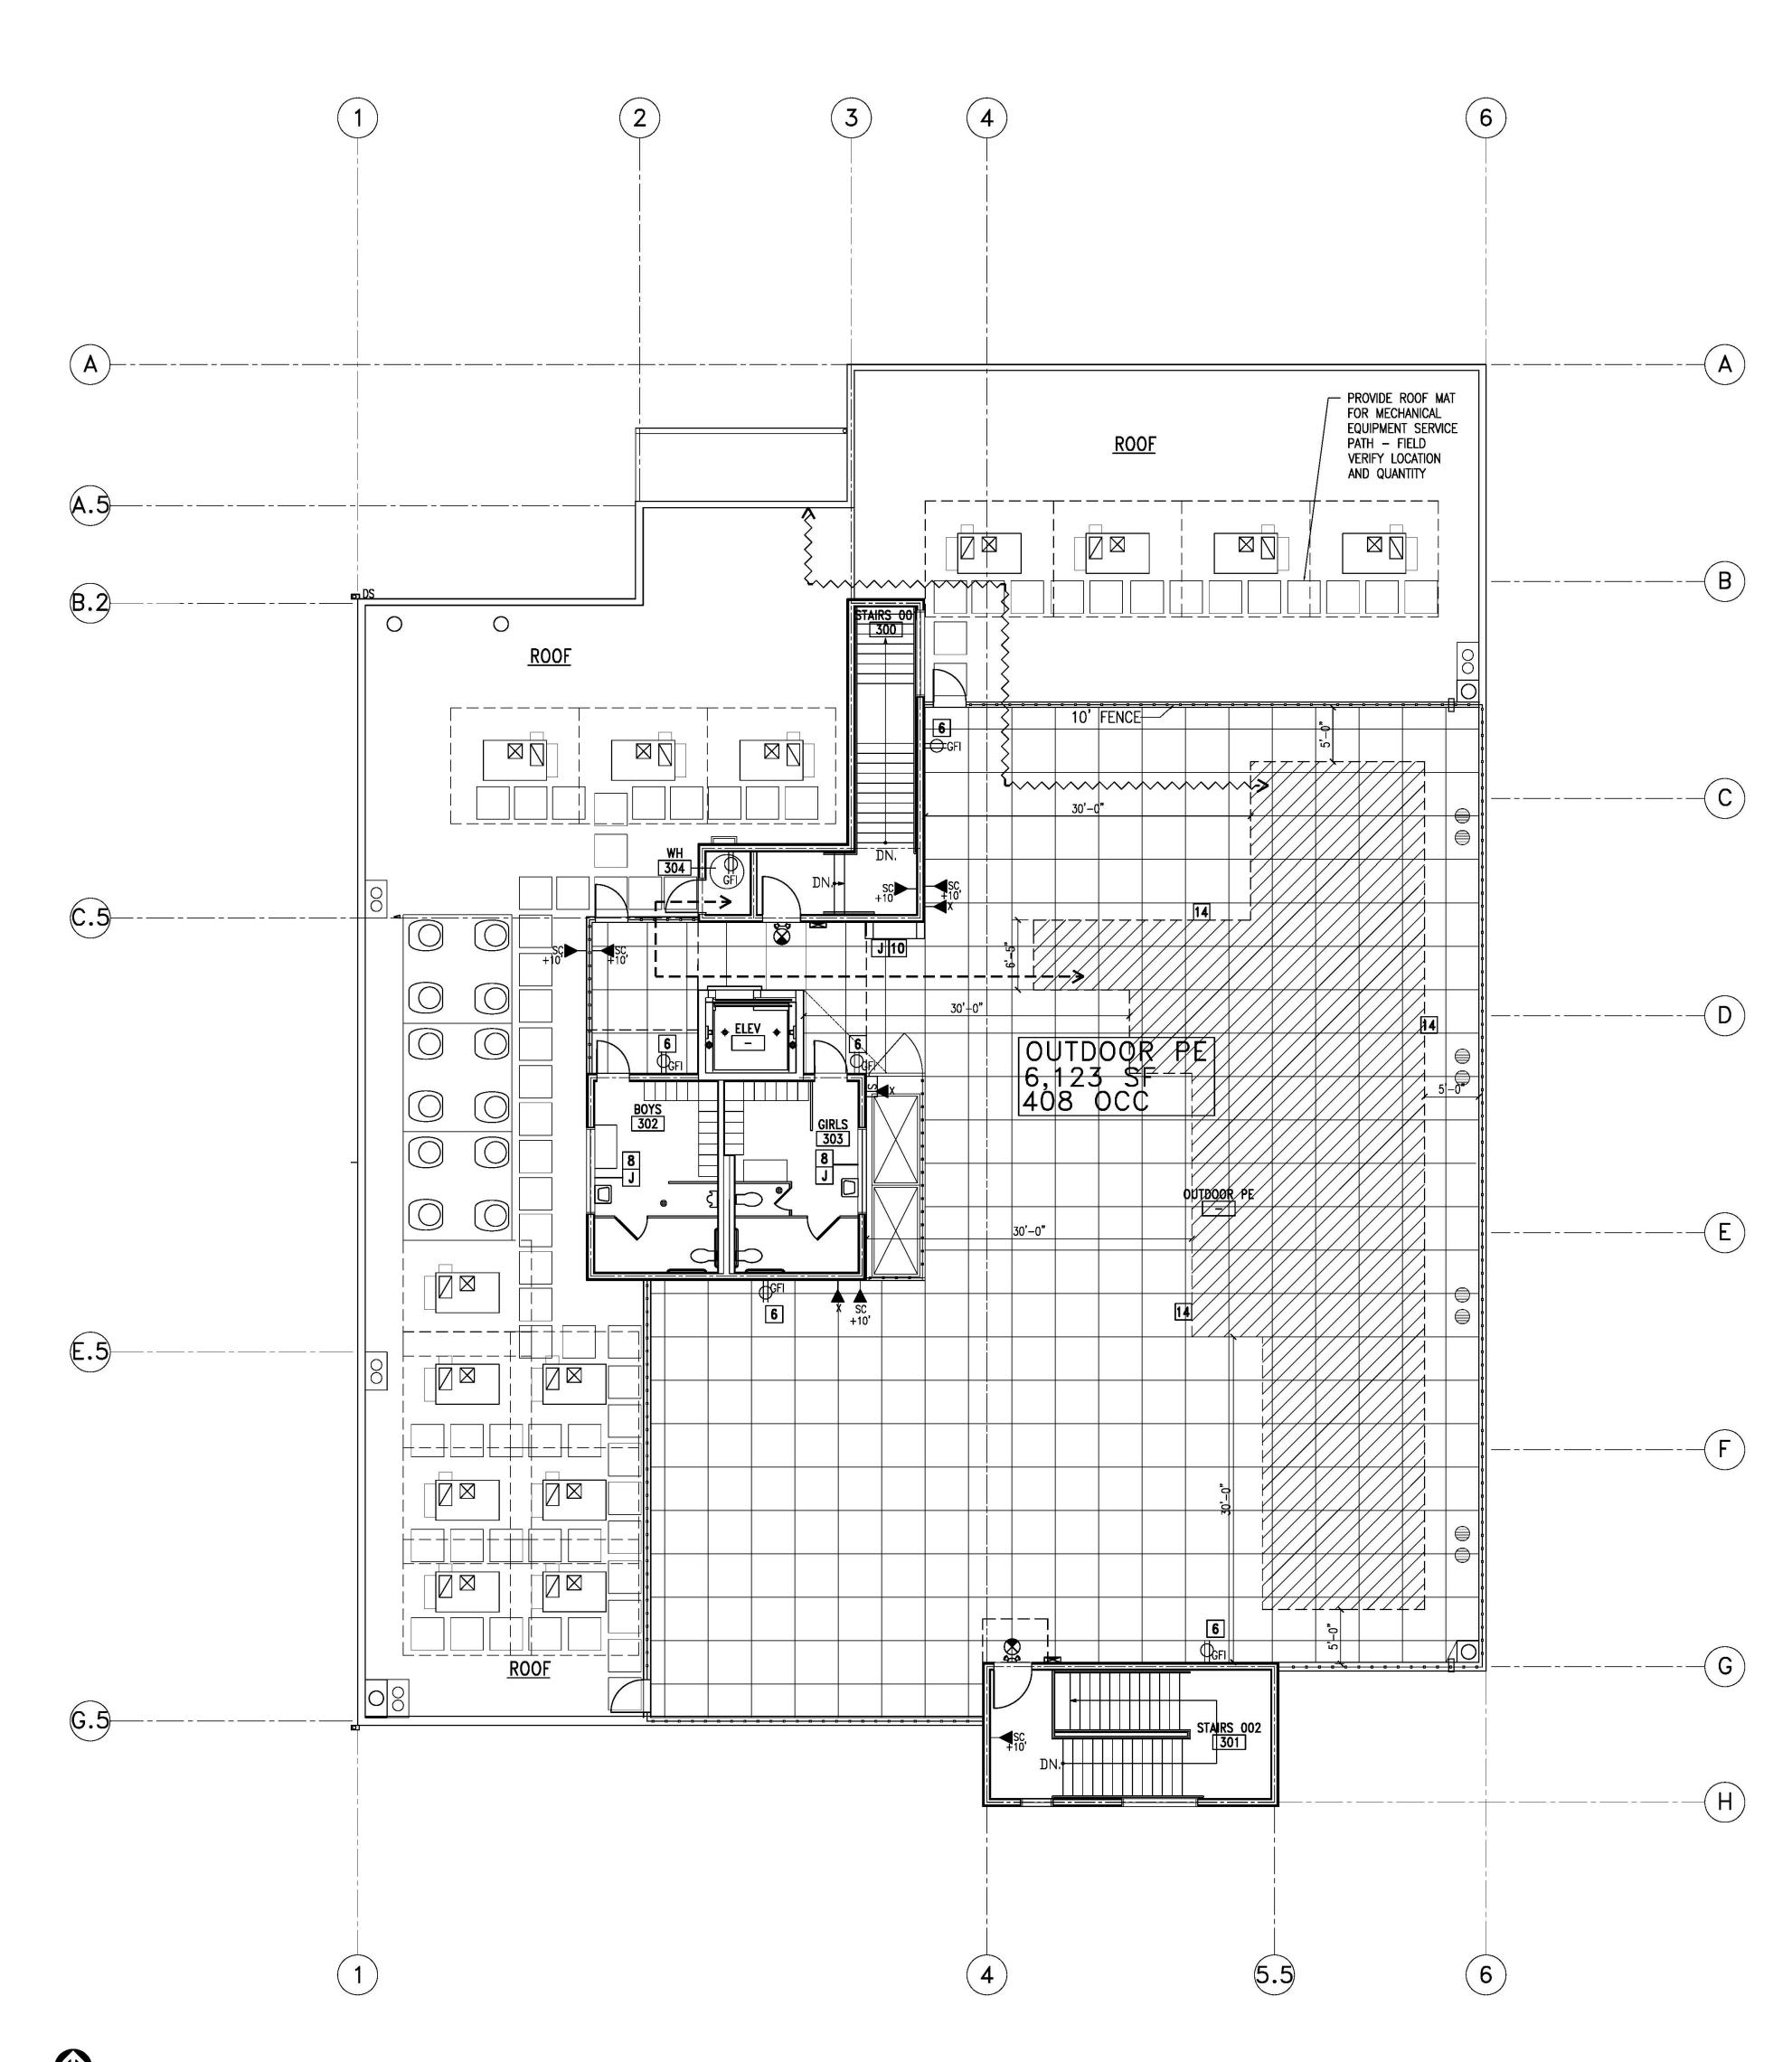

SCALE: 1/8" = 1'-0"

FIXTURE SYMBOLS

ISOLIT ELT SERIES CLEAR W/ WHITE TRIM & GREEN LETTERS EXIT LIGHT PER ELEC. PLANS COMPLIANCE WITH BLDG. CODE SEC. 1003.2.8.1. SURFACE MTD.; (L) SELF-ILLUMINATED LOW LEVEL EXIT SIGN PROVIDED CONJUNCTION WITH EXIT SIGNAGE PACKAGE (WHERE SHOWN) INTERNALLY ILLUMINATED FLOOR LEVEL EXIT SIGN PROVIDED IN ALL INTERIOR CORRIDORS (1011.6)

2'x4' RECESSED LED LIGHT FIXTURE; BY COOPER LIGHTING EATON 24AC-LD4-44-UNV-L840

13"x4' SURFACE MOUNTED LED LIGHT FIXTURE; BY LAMAR LIGHTING VGAL SERIES- 48-L-40

6-INCH RECESSED LED FIXTURE; BY COOPER LIGHTING EATON HALO COMMERCIAL- PD6-30-D010-PDM6A-835-61V-C

8"x4' SURFACE MOUNTED LED LIGHT FIXTURE; BY <u>COOPER LIGHTING EATON</u> 4-LED4-40SL-F-UNV-L835-CD-1-U

4"x8' SURFACE MOUNT LED LIGHT FIXTURE; BY FOCAL POINT E-X SEEM 4 LED: FSM4LS-FL-625LF-1C-UNV-LD1-SM-WH-8' PROVIDE WITH BUILT-IN OCCUPANCY SENSOR. 4"x4' SURFACE MOUNT LED LIGHT FIXTURE; BY FOCAL POINT SEEM 4 LED: FSM4LS-FL-625LF-1C-UNV-LD1-SM-WH-4' PROVIDE WITH BUILT-IN OCCUPANCY SENSOR.

> 2'- SURFACE MOUTED LED LIGHT FIXTURE; BY <u>FORUM</u> SAD-34-30-SAT-S-2'-120V-WH 4'- SURFACE MOUTED LED LIGHT FIXTURE; BY <u>FORUM</u> SAD-34-30-SAT-S-4'-120V-WH

7"x4' WALL MOUNT LED LIGHT FIXTURE; BY <u>FOCAL POINT</u> H-4' VERVE IV LED- FV4LW-FL-625LF-1C-UNV-LD1-WM-WH-4'

TYPE	DESCRIPTION	MANUFACTURER	CAT NO.	LAMP	VOLT	LUMENS	WATTS
А	RECESSED TROFFER	COLUMBIA LTG	LEPC-24-40-MW-G-LL-ED	LED	UNV	3400	32
	2X4LED		Х-				
В	SURFACE MOUNTED	COLUMBIA	LCAT14-40-MW-G-	LED	UNV	2424	28
D	2X4LED	COLUMBIA	ED-X	LED	UNV	2424	20
	ZAALED		ED-X				
С	RECESSED LED DOWNLIGHT	PRESCOLITE	LF6ML-X-6LFML30L-40K	LED	UNV	3000	35
	6"		X-FLU-X-CL				
	OVA CUREAGE MOUNTED MIDAR	OOLUMBIA LTO	1 A VAV 4 OF BALL ED V	155	LIND	4000	40
D	8X4 SURFACE MOUNTED WRAP LINEAR	COLUMBIA LTG	LAW-4-35-ML-ED-X-	LED	UNV	4982	43
	LINEAR						
E-X	4X8 SURFACE MOUNTED LED	PRUDENTIA LTG	P40-LED4-lo-8-X-SAL-D1-	LED	UNV	3600	36
			X-X-DM10-				
_	2' LED FIXTURE	PRUDENTIA LTG	DAOLEDA LO O VICAL DA	LED	UNV	900	11
F	2 LED FIXTURE	PRODENTIA LIG	P40-LED4-LO-2-X-SAL-D1	LED	UNV	900	11
			SC-X-X-DM10-				
H-4	WALL MOUNTED LED FIXTUE	LITECONTROL	13L-W-ID-STD-4-SOF-X-	LED	UNV	2500	30.5
			40K-900D10-1-X				

SYMBOL LIST WATT STOPPER

LMBC-300 NETWORK BRIDGE. FOR NETWORKING ROOMS TOGETHER FOR BMS OR DEMAND RESPONSE.

LMSM-3E SEGMENT MANAGER USED TO RECEIVE COMMUNICATION FROM BMS OR SIGNAL FOR DEMAND RESPONSE LMRC-211 (1) RELAY ROOM CONTROLLER W/O-10 VOLT

DIMMING RELAY ROOM CONTROLLER W/O-10 VOLT DIMMING.

LMRC-212 (2) RELAY ROOM CONTROLLERS W/O-10 VOLT LMRC-213 (3) RELAY ROOM CONTROLLERS W/0-10 VOLT

LMDC-100 LOW VOLTAGE DIGITAL DUAL TECH CEILING

MOUNTED OCC SENSOR LMDW-102 DUAL TECH 2 BUTTON WALL OCCUPANCY SENSOR

\$sw LMSW-104 DIGITAL 4 BUTTON SWITCH

LMLS-400 SINGLE ZONE PHOTO SENSOR

LMLS-500 MULTI ZONE PHOTO SENSOR

DSW-100 LINE VOLTAGE 1 BUTTON WALL OCCUP SENSOR

LMPL-101 PLUG LOAD CONTROLLER RATED 20 AMPS P101

EMERGENCY LIGHTING CONTROL UNIT

\$ DIM WALL MOUNTED DIMMER SWITCH

MAGNOLIA SCIENCE ACADEMY

A SCIENCE ,


18220 SHERMAN WAY, RESEDA, CA 91335

FIRST FLOOR REFLECTED CEILING PLAN ISSUE DATE 2/17/201


AS NOTED

JOB NUMBER

APPROVED BY:

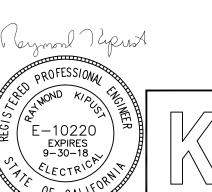



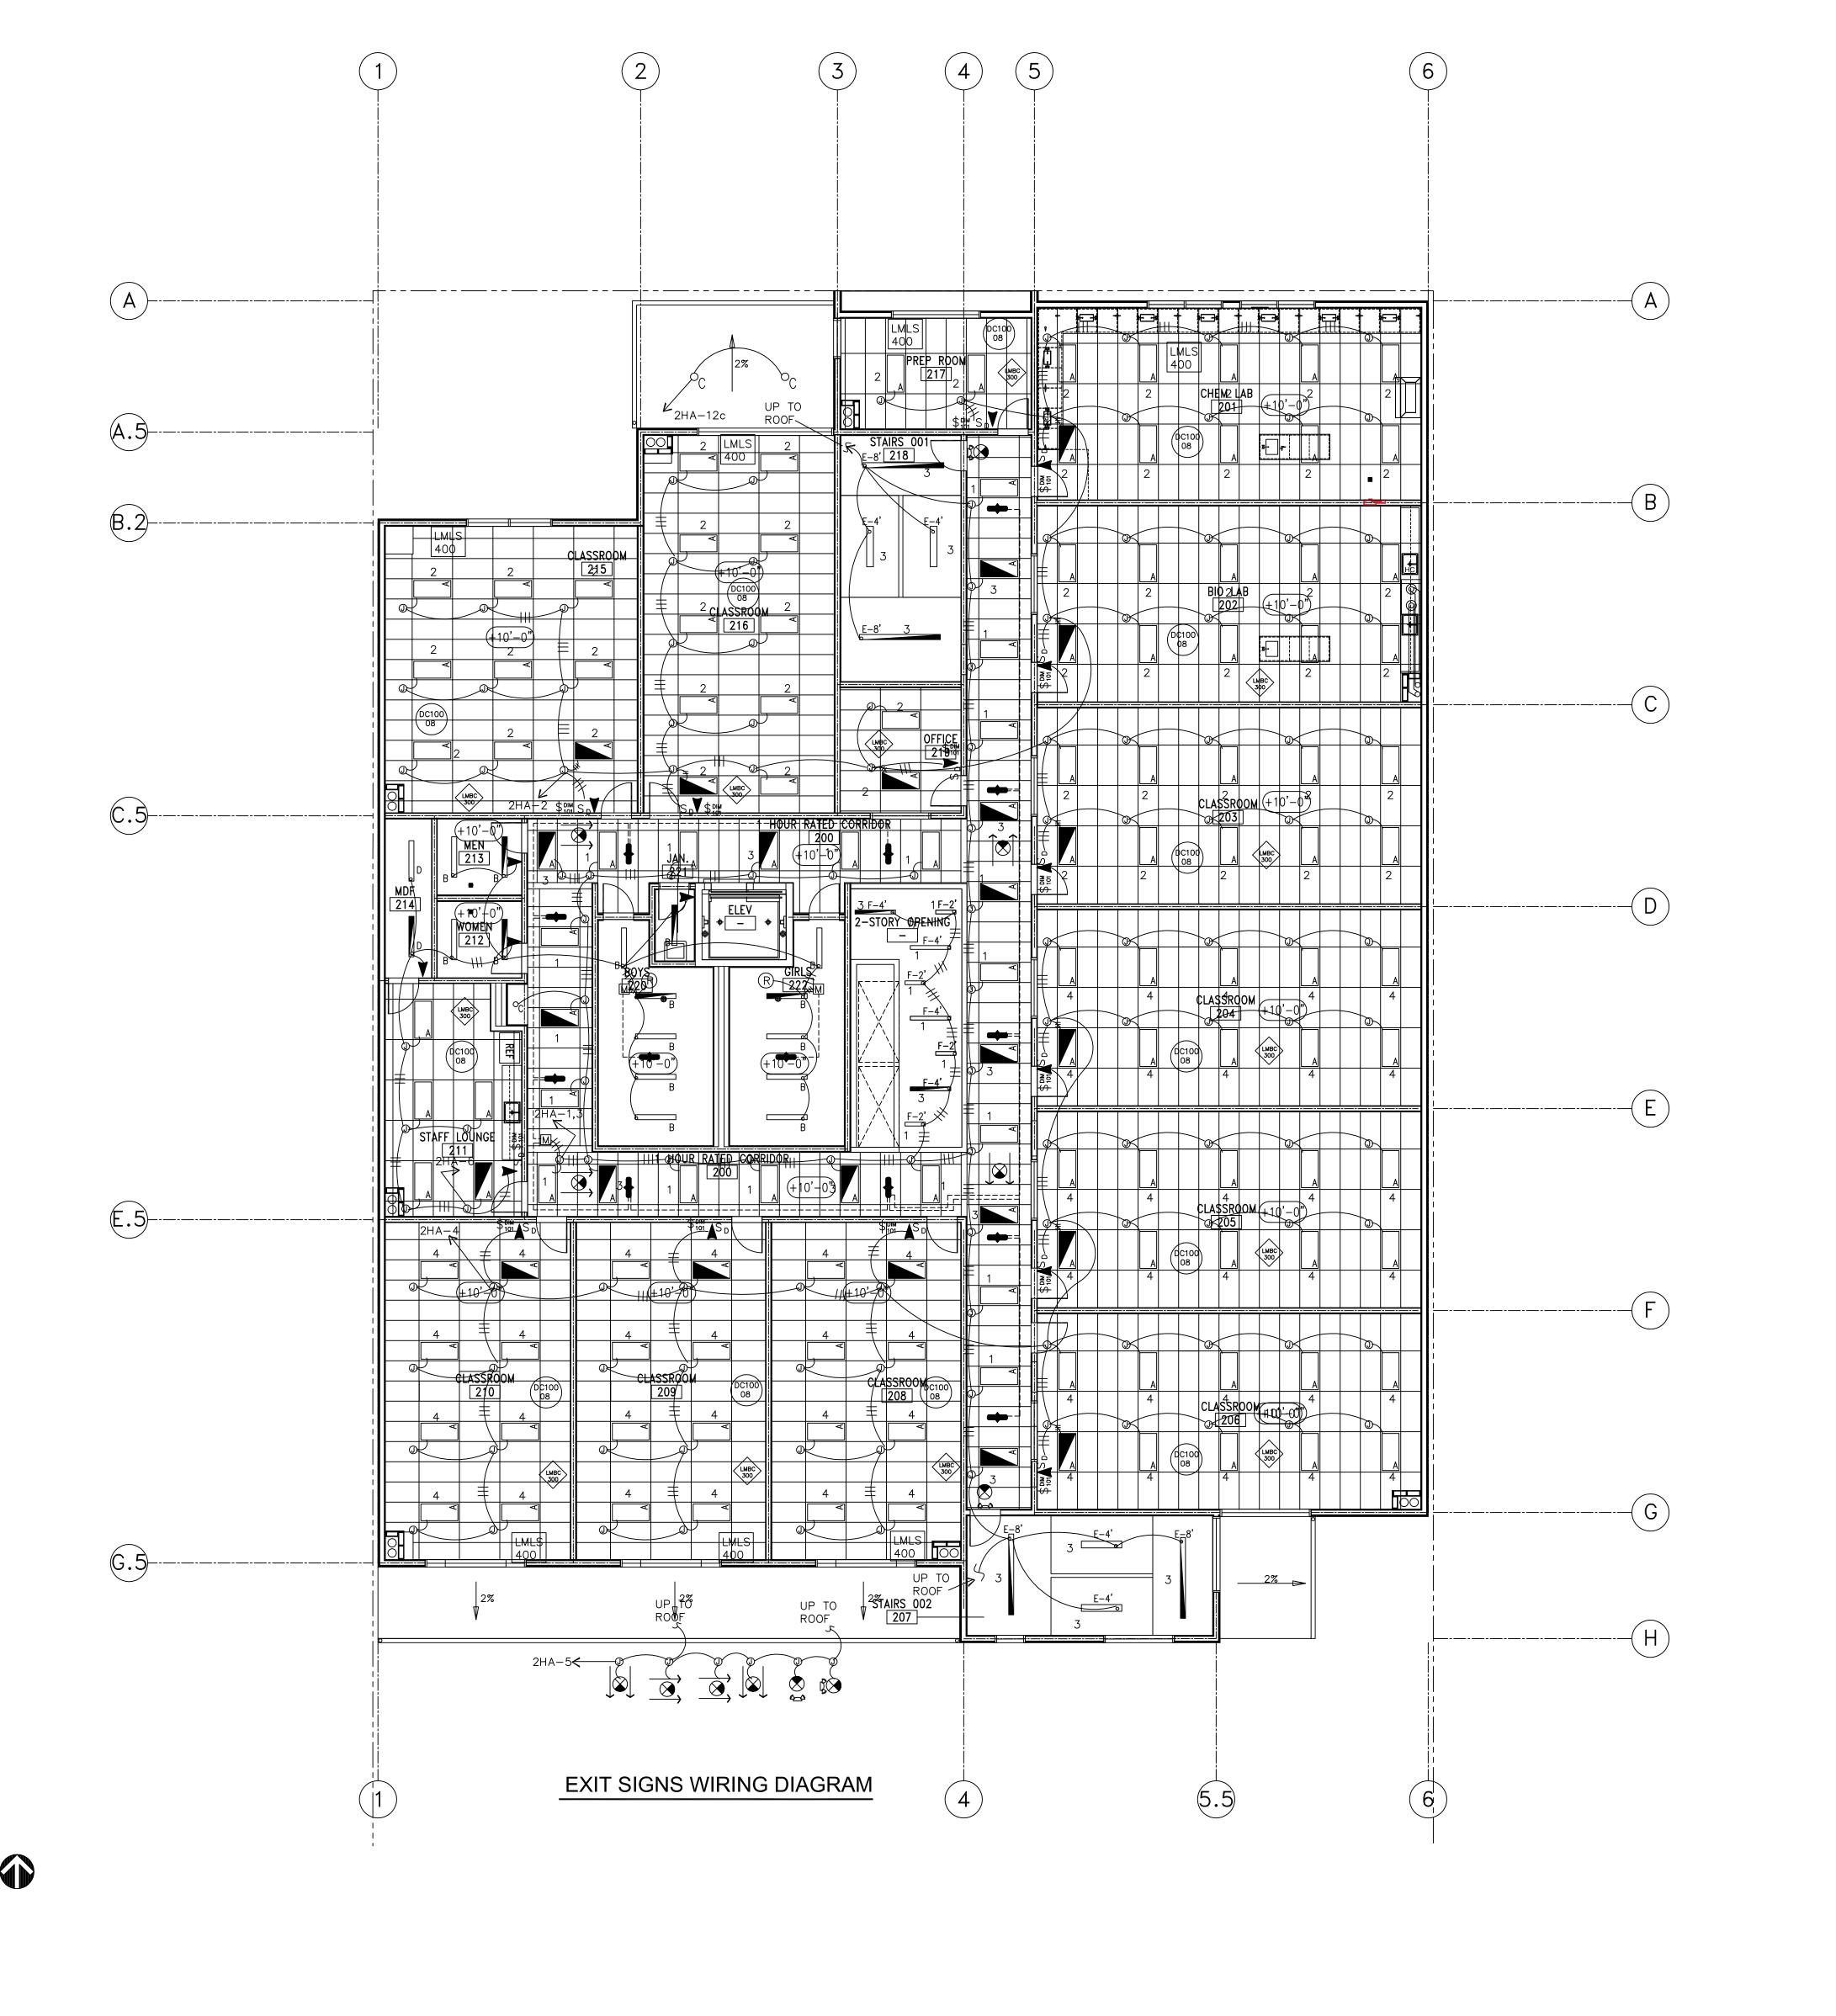

SECOND REFLECTED CEILING PLAN

SCALE: 1/8" = 1'-0"

FIXTURE SYMBOLS

ISOLIT ELT SERIES CLEAR W/ WHITE TRIM & GREEN LETTERS EXIT LIGHT PER ELEC. PLANS COMPLIANCE WITH BLDG. CODE SEC. 1003.2.8.1. SURFACE MTD.; (L) SELF-ILLUMINATED LOW LEVEL EXIT SIGN PROVIDED CONJUNCTION WITH EXIT SIGNAGE PACKAGE (WHERE SHOWN) INTERNALLY ILLUMINATED FLOOR LEVEL EXIT SIGN PROVIDED IN ALL INTERIOR CORRIDORS (1011.6)

2'x4' RECESSED LED LIGHT FIXTURE; BY COOPER LIGHTING EATON 24AC-LD4-44-UNV-L840

13"x4' SURFACE MOUNTED LED LIGHT FIXTURE; BY LAMAR LIGHTING

VGAL SERIES- 48-L-40

6-INCH RECESSED LED FIXTURE; BY COOPER LIGHTING EATON

8"x4' SURFACE MOUNTED LED LIGHT FIXTURE; BY COOPER LIGHTING EATON 4-LED4-40SL-F-UNV-L835-CD-1-U

HALO COMMERCIAL- PD6-30-D010-PDM6A-835-61V-C

4"x8' SURFACE MOUNT LED LIGHT FIXTURE; BY FOCAL POINT E-X SEEM 4 LED: FSM4LS-FL-625LF-1C-UNV-LD1-SM-WH-8' PROVIDE WITH BUILT-IN OCCUPANCY SENSOR. 4"x4' SURFACE MOUNT LED LIGHT FIXTURE; BY FOCAL POINT SEEM 4 LED: FSM4LS-FL-625LF-1C-UNV-LD1-SM-WH-4' PROVIDE WITH BUILT-IN OCCUPANCY SENSOR.

2'- SURFACE MOUTED LED LIGHT FIXTURE; BY FORUM SAD-34-30-SAT-S-2'-120V-WH 4'- SURFACE MOUTED LED LIGHT FIXTURE; BY FORUM SAD-34-30-SAT-S-4'-120V-WH

7"x4' WALL MOUNT LED LIGHT FIXTURE; BY FOCAL POINT VERVE IV LED- FV4LW-FL-625LF-1C-UNV-LD1-WM-WH-4

TYPE	DESCRIPTION	MANUFACTURER	CAT NO.	LAMP	VOLT	LUMENS	L
							╙
Α	RECESSED TROFFER	COLUMBIA LTG	LEPC-24-40-MW-G-LL-ED	LED	UNV	3400	L
	2X4LED		X-				
В	SURFACE MOUNTED	COLUMBIA	LCAT14-40-MW-G-	LED	UNV	2424	\vdash
	2X4LED		ED-X				
С	RECESSED LED DOWNLIGHT	PRESCOLITE	LF6ML-X-6LFML30L-40K	LED	UNV	3000	\vdash
	6"	11,20002112	X-FLU-X-CL		0111	0000	
D	8X4 SURFACE MOUNTED WRAP	COLUMBIA LTG	LAW-4-35-ML-ED-X-	LED	UNV	4982	
	LINEAR						L
E-X	4X8 SURFACE MOUNTED LED	PRUDENTIA LTG	P40-LED4-lo-8-X-SAL-D1-	LED	UNV	3600	H
			X-X-DM10-				
F	2' LED FIXTURE	PRUDENTIA LTG	P40-LED4-LO-2-X-SAL-D1	LED	UNV	900	┝
			SC-X-X-DM10-				
H-4	WALL MOUNTED LED FIXTUE	LITECONTROL	13L-W-ID-STD-4-SOF-X-	LED	UNV	2500	H
			40K-900D10-1-X				

SYMBOL LIST WATT STOPPER

LMBC-300 NETWORK BRIDGE. FOR NETWORKING ROOMS TOGETHER FOR BMS OR DEMAND RESPONSE.

COMMUNICATION FROM BMS OR SIGNAL FOR DEMAND RESPONSE LMRC-211 (1) RELAY ROOM CONTROLLER W/O-10 VOLT

DIMMING RELÁY ROOM CONTROLLER W/0-10 VOLT DIMMING. LMRC-212 (2) RELAY ROOM CONTROLLERS W/O-10 VOLT

LMSM-3E SEGMENT MANAGER USED TO RECEIVE

LMRC-213 (3) RELAY ROOM CONTROLLERS W/O-10 VOLT

LMDC-100 LOW VOLTAGE DIGITAL DUAL TECH CEILING MOUNTED OCC SENSOR

LMDW-102 DUAL TECH 2 BUTTON WALL OCCUPANCY SENSOR

\$sw LMSW-104 DIGITAL 4 BUTTON SWITCH

LMLS-400 SINGLE ZONE PHOTO SENSOR

LMLS-500 MULTI ZONE PHOTO SENSOR

LMPL-101 PLUG LOAD CONTROLLER RATED 20 AMPS P101

DSW-100 LINE VOLTAGE 1 BUTTON WALL OCCUP SENSOR

EMERGENCY LIGHTING CONTROL UNIT

\$DIM WALL MOUNTED DIMMER SWITCH

MAGNOLIA SCIENCE ACADEMY

SCIENC IN WAY, RES

MAGNOLIA 18220 SHERMAI


REV DESCRIPTION DATE

18220 SHERMAN WAY, RESEDA, CA 91335

SECOND FLOOR REFLECTED CEILING PLAN

JOB NUMBER DRAWING SCALE AS NOTED APPROVED BY:


BID SET 03-07-18 KIPUST ENGINEERING, INC. 12931 KILLION ST. SHERMAN OAKS, CA 91401 (818) 780-5354 FAX (818) 780-7036

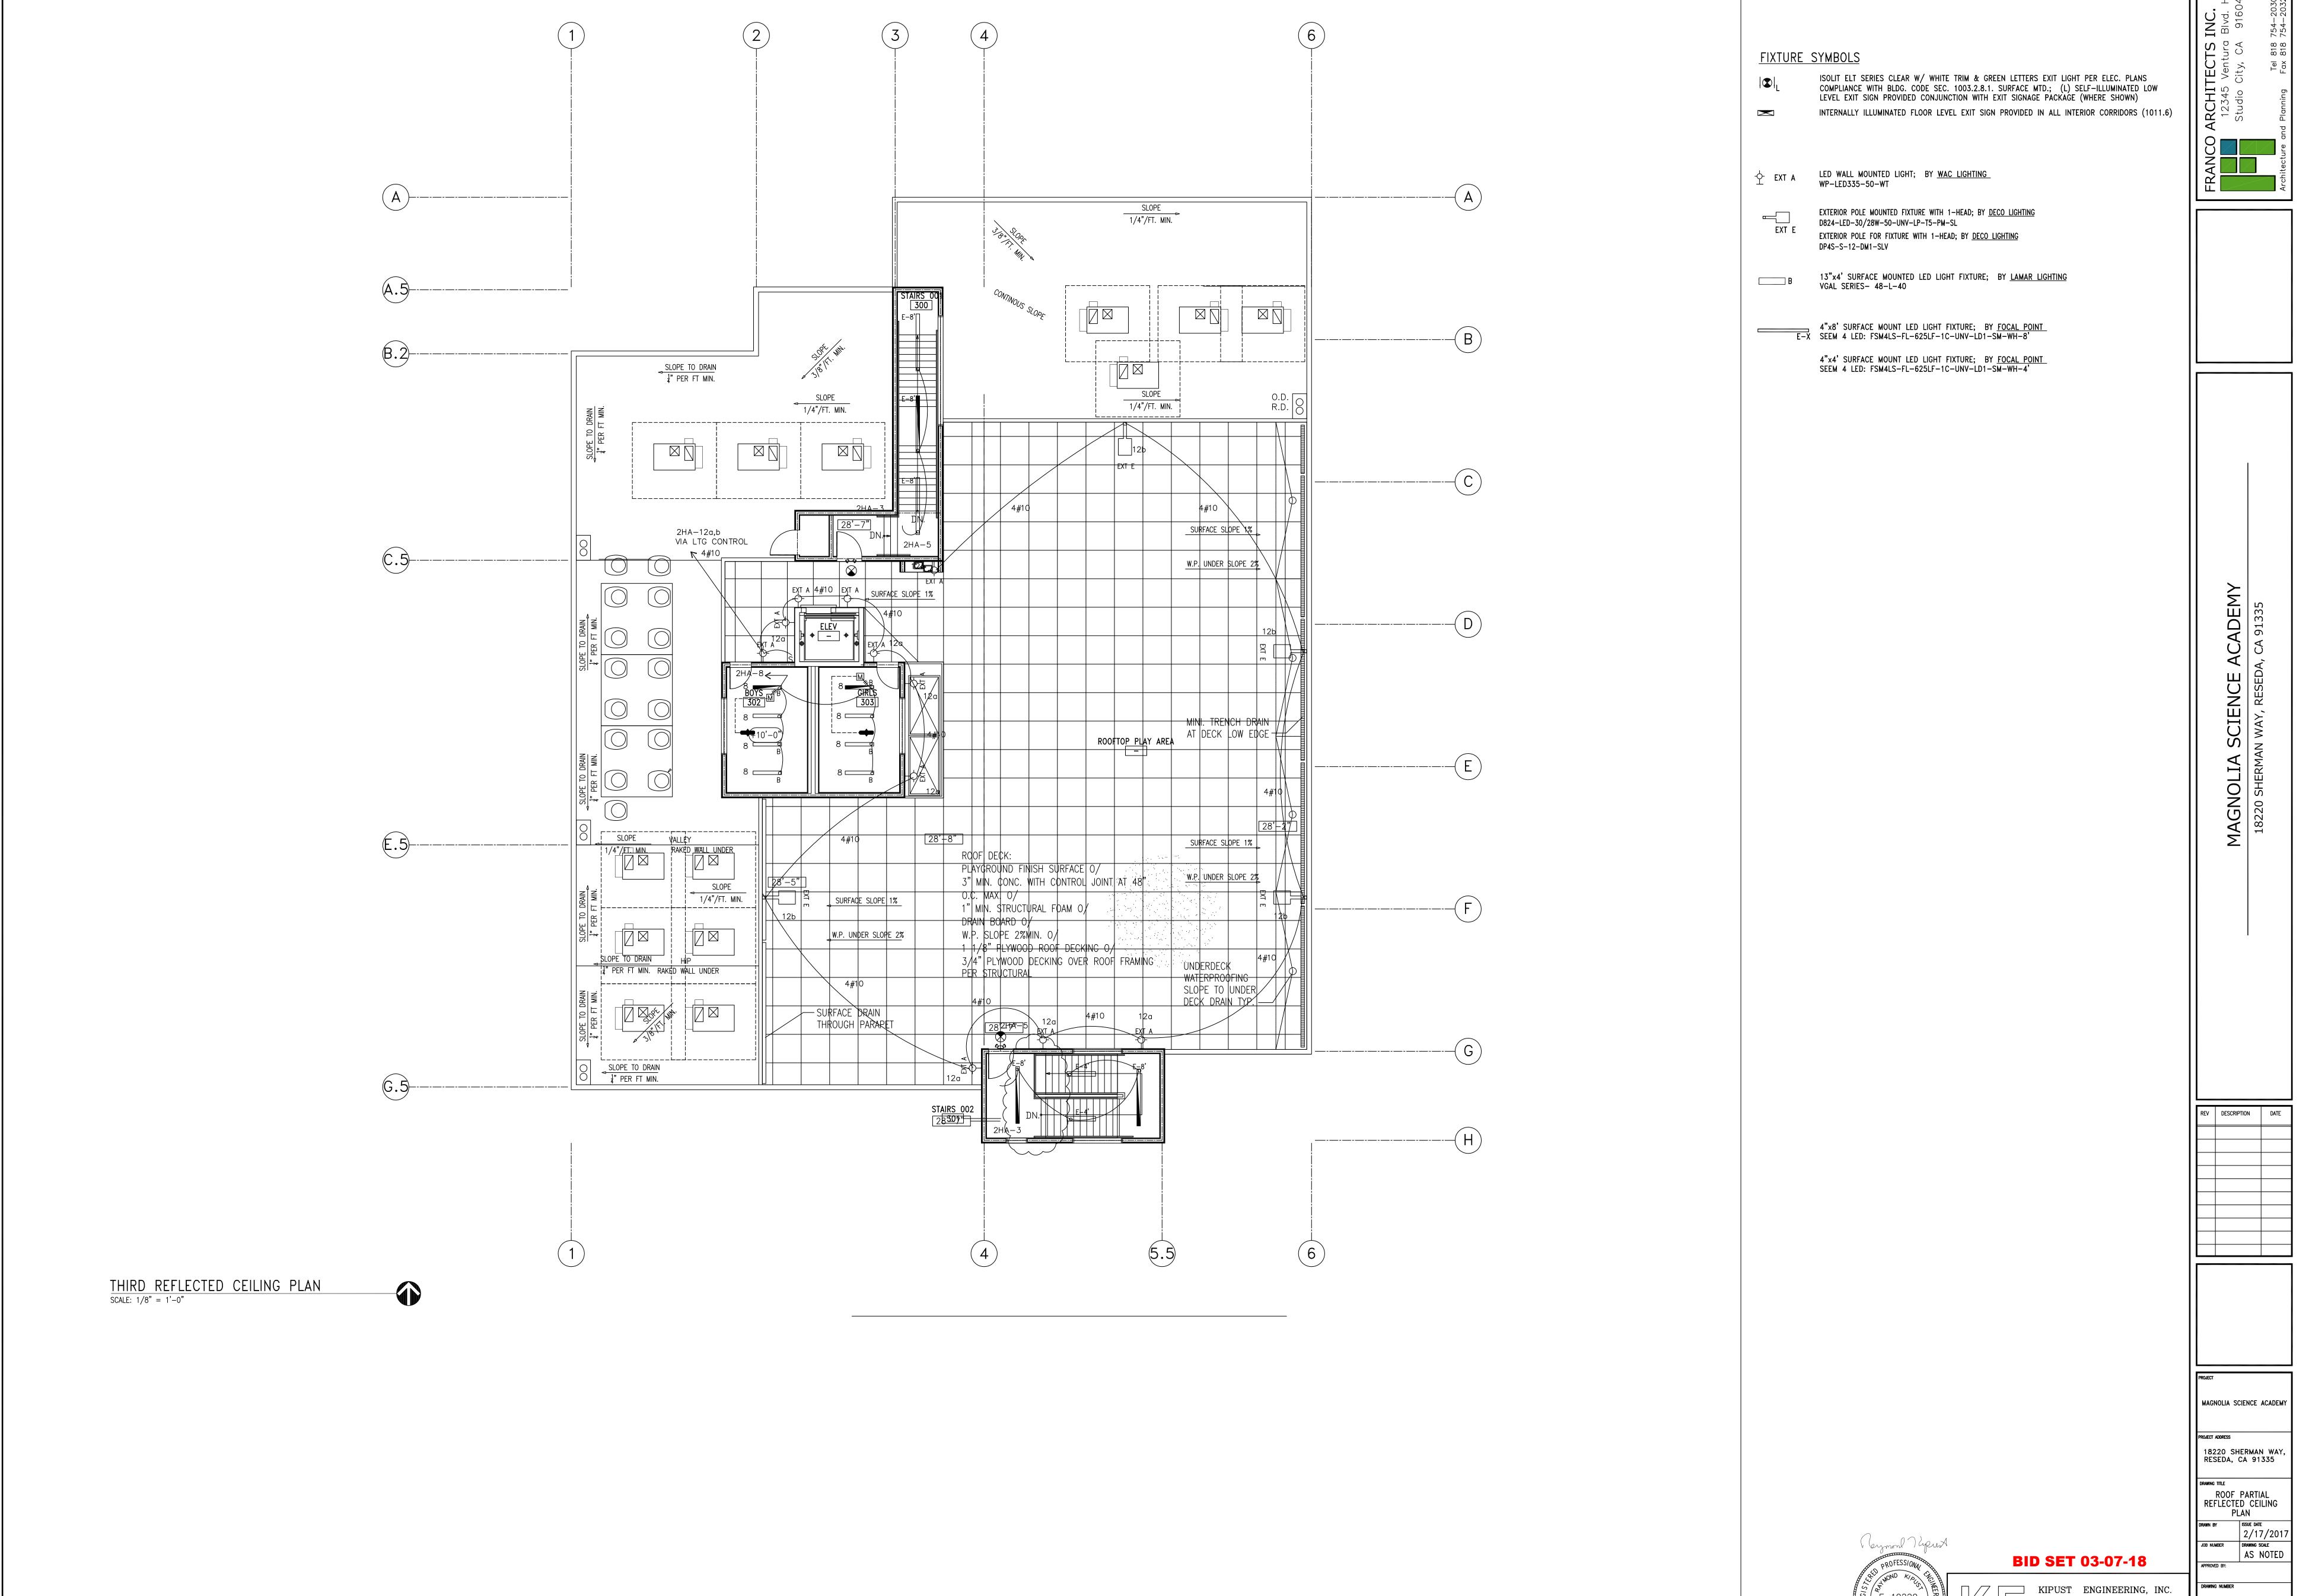

REV DESCRIPTION DATE

MAGNOLIA SCIENCE ACADEMY

12931 KILLION ST. SHERMAN OAKS, CA 91401 (818) 780-5354 FAX (818) 780-7036

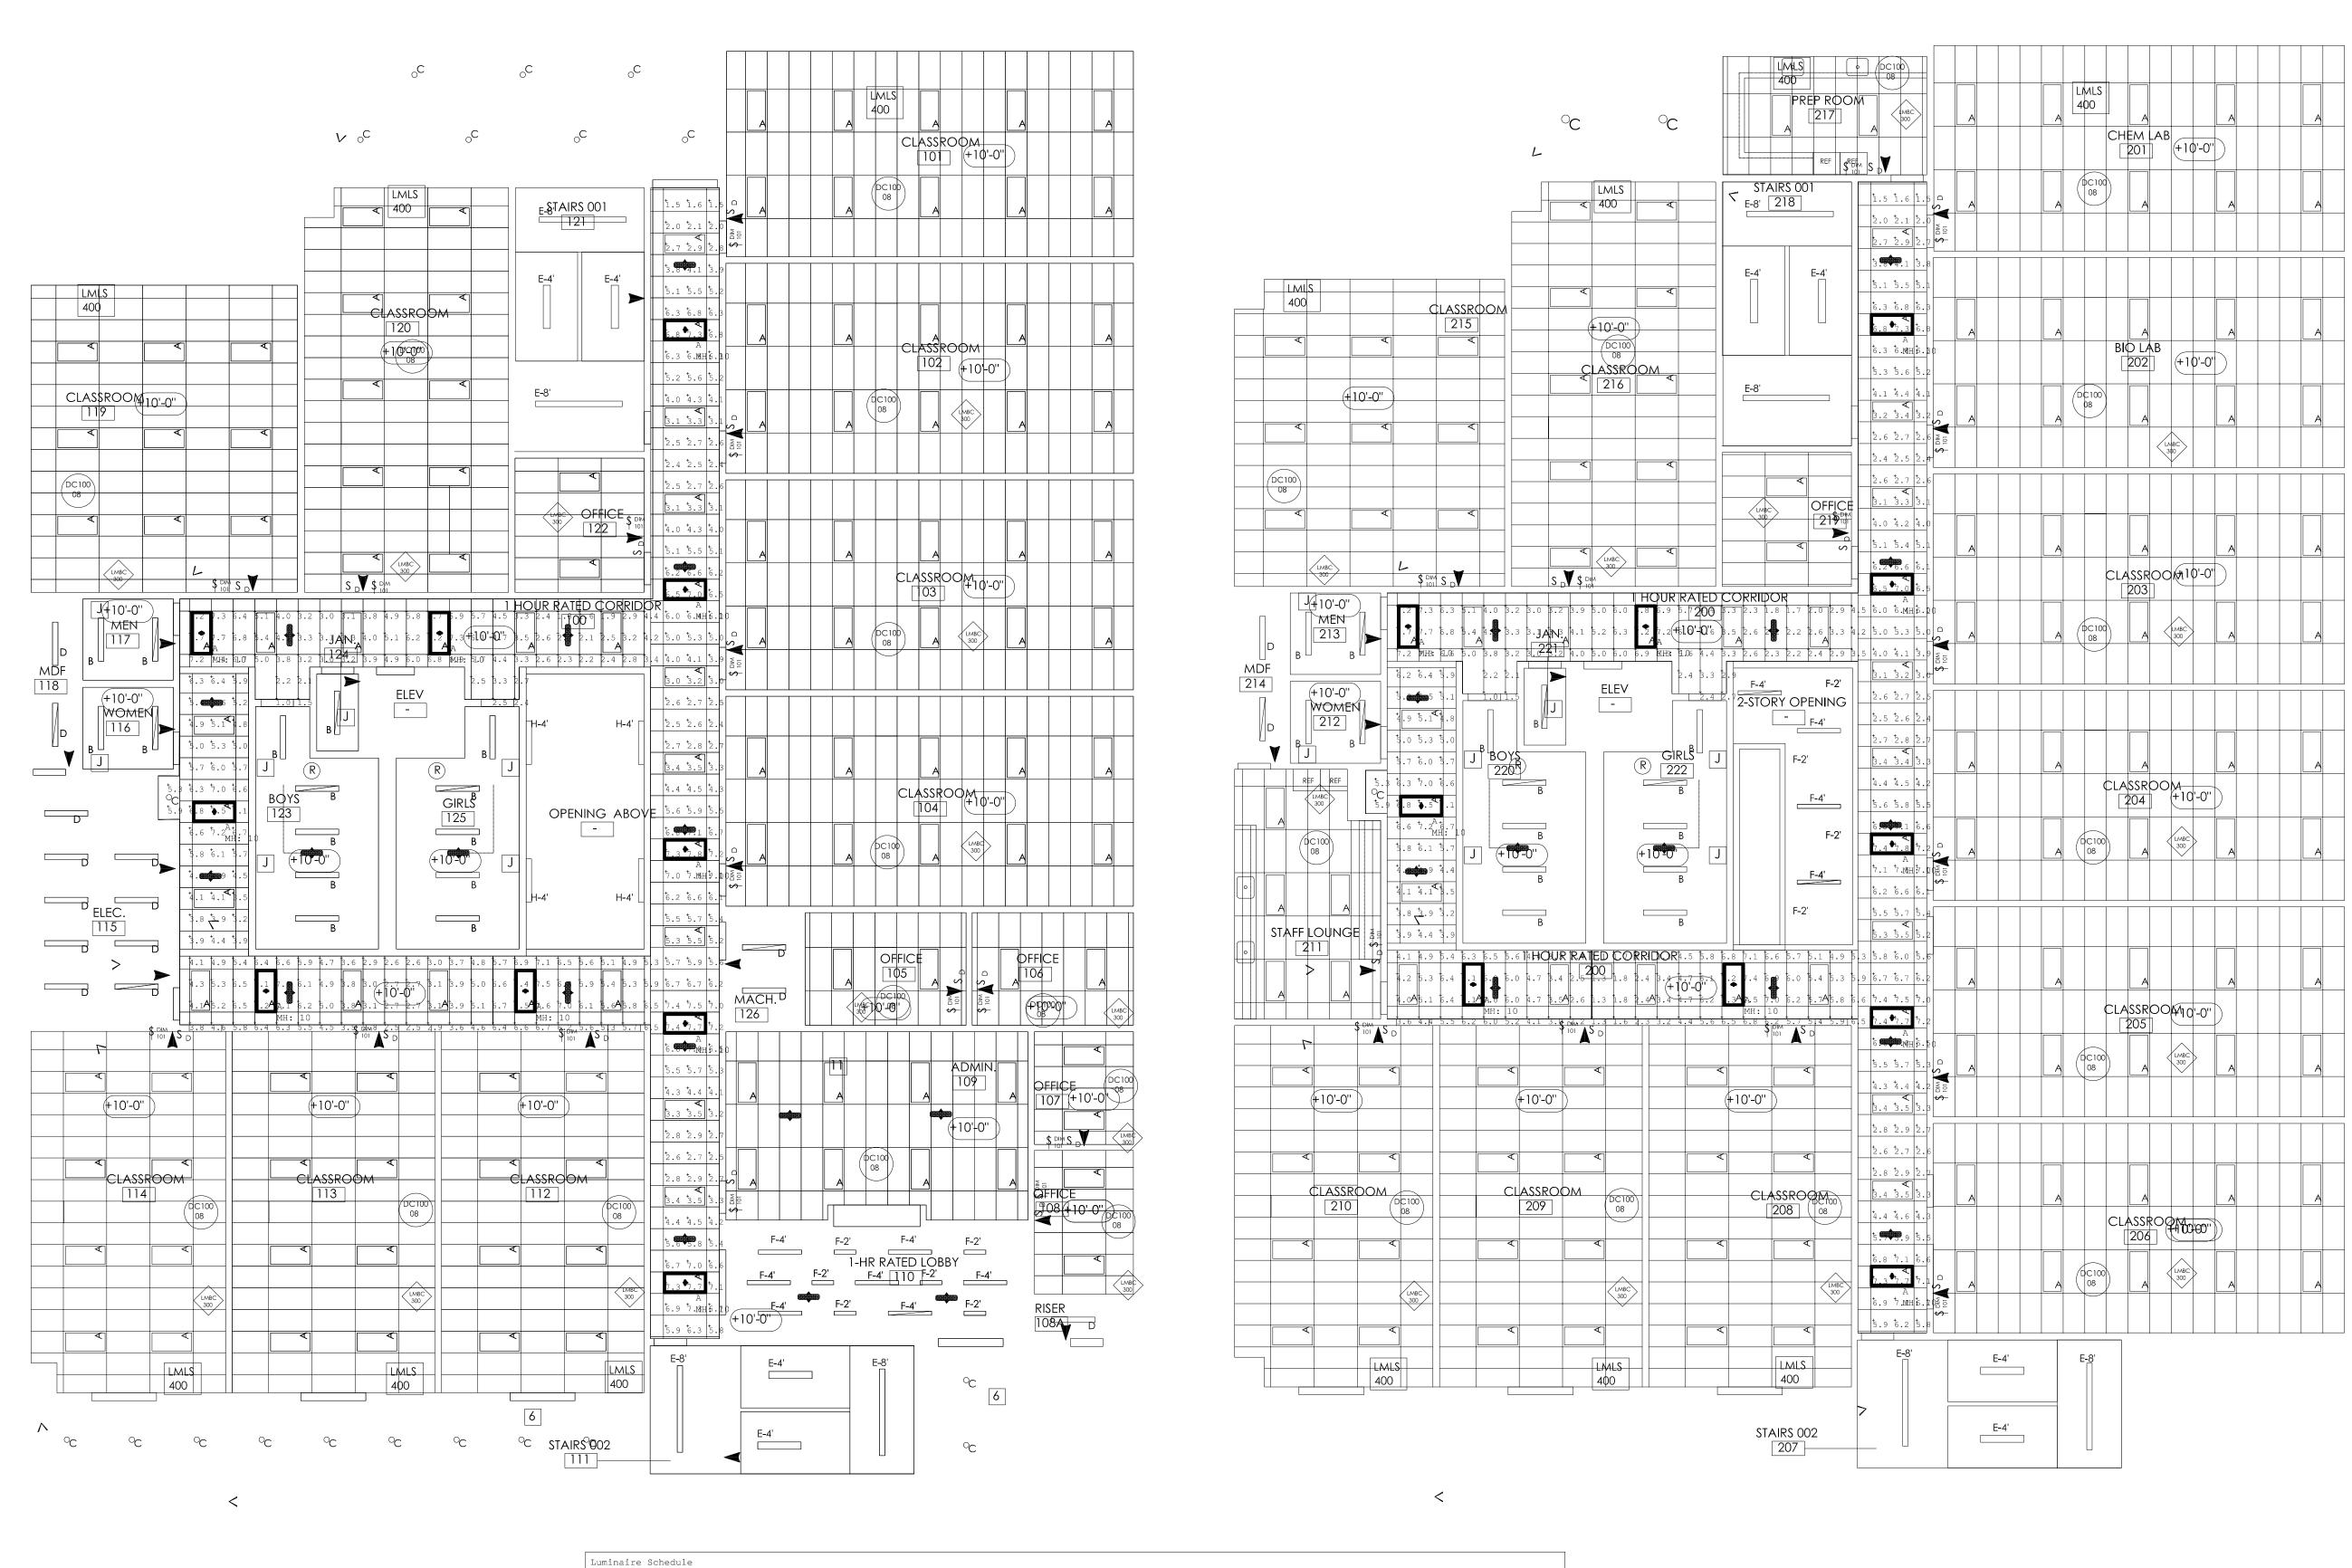

Symbol Qty Label Arrangement Total Lamp Lumens LLF Description

20 A SINGLE N.A. 0.370 Columbia // LEPC24-40MW-EU-ELL14

Calculation Summary

 Label
 CalcType
 Units
 Avg
 Max
 Min
 Avg/Min
 Max/Min

 Corridor_100_Floor
 Illuminance
 Fc
 4.83
 7.8
 1.0
 4.83
 7.80

 Corridor_200_Floor
 Illuminance
 Fc
 4.77
 7.8
 1.0
 4.77
 7.80

Magnolia Science Academy____1-30-2018.AGI Report for:Marisela Ekindjian Report by: Ismael Avina / Applications Engineer Mounting Ht.: See Drawing See Luminaire Schedule for Light Loss Factor - Unless otherwise specified by custon

See Luminaire Schedule for Light Loss Factor - Unless otherwise specified by customer Reflectance: 80/50/20 - Unless otherwise specified by customer Date:1/30/2018

Luminaire data is obtained according to IES procedures under controlled laboratory conditions. Field results may differ from computer predictions due to many uncontrollable factors including, but not limited to Line Voltage Variations, Lamp Performance, Ballast input watts, LED Drivers input watts, Temperature Variations and Jobsite Conditions.

PROFESSIONAL PROFESSIONAL PROFESSIONAL PROFESSIONAL PROPESSIONAL PROPE

BID SET 03-07-18

KIPUST ENGINEERING, INC.

CONSULTING ELECTRICAL ENGINEERS
12931 KILLION ST. SHERMAN OAKS, CA 91401
(818) 780-5354 FAX (818) 780-7036

DRAWING NUMBER

MAGNOLIA SCIENCE ACADEMY

18220 SHERMAN WAY, RESEDA, CA 91335

1ST & 2ND FLOOR

EMERGENCY PHOTOMETRIC

AS NOTED

PROJECT ADDRESS

MAGNOLIA 18220 SHERM

DESCRIPTION

PLAN CHECK RESUBMISSION 02-07-18